





MISS FIONA MACLEOD

Our Ref: MCU191 Doc No: 549386

18 March 2021

South West Indigenous Corporation Paul Kelly C/- Precinct Urban Planning PO Box 3038 TOOWOOMBA QLD 4350

Via email: paul@precinctplan.com.au

Attention:

Paul Kelly

Dear Paul,

Decision notice approval

(Given under section 63(2) of the Planning Act 2016)

The development application described below was properly made to the Balonne Shire Council on 5 February 2021.

Applicant details

Applicant name:

South West Indigenous Corporation

Paul Kelly

C/- Precinct Urban Planning

Applicant contact details:

PO Box 3038

TOOWOOMBA QLD 4350 Email: paul@precinctplan.com.au

Application details

Application number:

MCU191

Approval sought:

Development Permit

Details of proposed

development:

Development application for Material Change of Use – "Community Use"

Location details

Street address:

72-76 Saint Georges Terrace, St George QLD 4487

Real property description:

Lot 6 on RP98584 Lot 7 on RP98584 Lot 8 on RP98584

Decision

I wish to advise that, on 18 March 2021, the above development application was **approved in full** subject to conditions by Council. (Refer to the conditions contained in Attachment 1)

Details of the approval

This application is not taken to have been approved (a deemed approval) under section 64(5) of the *Planning Act* 2016.

The following approvals are given:

	Planning Regulation 2017 reference	Development Permit	Preliminary Approval
Development assessable under the planning scheme, superseded planning scheme, a temporary local planning instrument, a master plan or a preliminary approval which includes a variation approval - material change of use	N/A		

Further development permits

Please be advised that the following development permits are required to be obtained before the development can be carried out:

Development Permit – Building Work

Properly made submissions

Not Applicable - No part of the application required public notification.

Referral agencies for the application

Not Applicable – No part of the application required referral.

Approved plans, specifications and drawings

Copies of the following approved plans, specifications and/or drawings are enclosed.



Plan/Document Number	Plan/Document Name	Date
19-1107 A.000	Proposed Site Locality Plan	23/12/20
19-1107 A.010	Existing/Demolition Site Plan	23/12/20
19-1107 A.011	Proposed Site Plan	23/12/20
19-1107 A.100	Proposed Floor Plan	23/12/20
19-1107 A.200	Proposed Elevations	23/12/20
19-1107 A.201	Proposed Elevations	23/12/20
19-1107 A.210	Tilt Panel Elevations	23/12/20
19-1107 A.211	Tilt Panel Elevations	23/12/20
19-1107 A.300	Proposed Sections	23/12/20
19-1107 A.250	Proposed Streetscape Elevation	23/12/20
19-1107 A.900	Perspectives	23/12/20
19-1107 A.901	Perspectives	23/12/20
2006-01 C	Landscape Plan	January 2021
2006-02 C	Proposed Plants & Elevations	January 2021
S1920193 – C01	Schematic Design Site Civil Works Layout – Notes and Details	
S1920193 – C02	Schematic Design Site Civil Works Layout – Sheet 1 of 2	
S1920193 – C03	Schematic Design Site Civil Works Layout – Sheet 2 of 2	
S1920193 – C04	Schematic Design Stormwater Drainage Layout – Sheet 1 of 2	
S1920193 – C05	Schematic Design Stormwater Drainage Layout – Sheet 2 of 2	<u> </u>
S1920193 – H01	Schematic Design Hydraulic Services Layout – Site Plan, Notes and Details	
S1920193 – H02	Schematic Design Hydraulic Services Layout – Sanitary Drainage	
S1920193 – H03	Schematic Design Hydraulic Services Layout – Water Reticulation	_
S1920193 - H04	Schematic Design Roof Drainage Layout	
S1920193 - S01	Schematic Design Structural Notes Sheet	
S1920193 – S02	Schematic Design Footing and Floor Slab Layout	_
S1920193 - S03	Schematic Design Roof Framing Layout	

Currency period for the approval (s.85 of the Planning Act)

For Material Change of Use - This approval lapses if the first change of use does not happen within 6 years after the approval starts to have effect.



Appeal Rights

The rights of an applicant to appeal to a tribunal or the Planning and Environment Court against a decision about a development application are set out in chapter 6, part 1 of the *Planning Act 2016*. For certain applications, there may also be a right to make an application for a declaration by a tribunal (see chapter 6, part 2 of the *Planning Act 2016*).

Appeal by an applicant

An applicant for a development application may appeal to the Planning and Environment Court against the following:

- the refusal of all or part of the development application
- a provision of the development approval
- the decision to give a preliminary approval when a development permit was applied for
- a deemed refusal of the development application.

An applicant may also have a right to appeal to the Development tribunal. For more information, see schedule 1 of the *Planning Act* 2016.

Appeal by an eligible submitter

An eligible submitter for a development application may appeal to the Planning and Environment Court against the decision to approve the application, to the extent the decision relates to:

- any part of the development application that required impact assessment
- a variation request.

The timeframes for starting an appeal in the Planning and Environment Court are set out in section 229 of the *Planning Act* 2016.

Attachment 2 is an extract from the *Planning Act 2016* that sets out the applicant's appeal rights and the appeal rights of a submitter.

To stay informed about any appeal proceedings which may relate to this decision visit: https://planning.dsdmip.gld.gov.au/planning/our-planning-system/dispute-resolution/pe-court-database.

For further information please contact Fiona Macleod, Planning and Development Officer on 07 4620 8842 or via email Fiona.macleod@balonne.qld.gov.au who will be pleased to assist.

Yours sincerely

Matthew Magin
Chief Executive Officer

Enc: Attachment 1—Assessment Manager Conditions of Approval (Balonne Shire Council)

Attachment 2—Appeal provisions

Attachment 3—Statement of Reasons

Attachment 4—Approved plans and specifications



ATTACHMENT 1 – ASSESSMENT MANAGER CONDITIONS OF APPROVAL (BALONNE SHIRE COUNCIL)

Preamble

- i. The relevant planning scheme for this development is *Balonne Shire Planning Scheme 2019*. All references to the 'Planning Scheme' and 'Planning Scheme Schedules' within these conditions refer to the above Planning Scheme.
- ii. Under the Balonne Shire Planning Scheme 2019 a "Community Use" means premises used for providing artistic, social or cultural facilities and community support services to the public and may include the ancillary preparation and provision of food and drink.
- iii. The *Environmental Protection Act 1994* states that a person must not carry out any activity that causes, or is likely to cause, environmental harm unless the person takes all reasonable and practicable measures to prevent or minimise the harm. Environmental harm includes environmental nuisance. In this regard, persons and entities involved in the operation of the approved development are to adhere to their 'general environmental duty' to minimise the risk of causing environmental harm to adjoining premises.
- iv. All Aboriginal Cultural Heritage in Queensland is protected under the *Aboriginal Cultural Heritage Act 2003* and penalty provisions apply for any unauthorised harm. Under the legislation a person carrying out an activity must take all reasonable and practicable measures to ensure the activity does not harm Aboriginal Cultural Heritage. This applies whether or not such places are recorded in an official register and whether or not they are located in, on or under private land. The developer is responsible for implementing reasonable and practical measures to ensure the Cultural Heritage Duty of Care Guidelines are met and for obtaining any clearances required from the responsible entity.
- v. It is the responsibility of the developer to obtain all necessary permits and submit all necessary plans and policies to the relevant authorities for the approved use.
- vi. An operational works application will be required to be submitted to and approved by Council where there would be a change 1m or more in the level of any part of the land or where any drainage path is affected; or for urban purposes that involve disturbing more than 2,500m² of land.
- vii. In completing an assessment of the proposed development, Council has relied on the information submitted in support of the development application as true and correct. Any change to the approved plans and documents may require a new or changed development approval. It is recommended to contact Council for advice in the event of any potential change in circumstances.

Use

- 1. The approved development is a Material Change of Use "Community Use" as defined in the Planning Scheme and as shown on the approved plans.
- 2. A development permit for building and plumbing works must be obtained prior to commencing construction of the community use.



3. The approved development is to be carried out generally in accordance with the following approved plans/documents and subject to approval conditions. Where there is any conflict between the approval conditions and the details shown on the approved plans, the approval conditions prevail.

Plan/Document Number	Plan/Document Name	Date
19-1107 A.000	Proposed Site Locality Plan	23/12/20
19-1107 A.010	Existing/Demolition Site Plan	23/12/20
19-1107 A.011	Proposed Site Plan	23/12/20
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S1920193 - C04	Schematic Design Stormwater Drainage Layout – Sheet 1 of 2	
S1920193 - C05	Schematic Design Stormwater Drainage Layout – Sheet 2 of 2	
S1920193 – H01	Schematic Design Hydraulic Services Layout – Site Plan, Notes and Details	
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S1920193 - S01	Schematic Design Structural Notes Sheet	
S1920193 - S02	Schematic Design Footing and Floor Slab Layout	
S1920193 - S03	Schematic Design Roof Framing Layout	

4. During the course of constructing the works, the developer shall ensure that all works are carried out by appropriately qualified persons and the developer and the persons carrying out and supervising the work shall be responsible for all aspects of the works, including public and worker safety, and shall ensure adequate barricades, signage and other warning devices are in place at all times.



Compliance inspection

- 5. All conditions relating to the establishment of the approved development must be fulfilled prior to the approved use commencing, unless otherwise noted in these conditions.
- 6. Prior to the commencement of the use, the applicant shall contact Council to arrange a development compliance inspection.

Applicable Standards

- 7. All works must comply with:
 - a. the development approval conditions;
 - b. any relevant provisions in the Planning Scheme;
 - c. Balonne Shire Council Private Property Entrance Policy 2010;
 - d. any relevant Australian Standard that applies to that type of work; and
 - e. any alternative specifications that Council has agreed to in writing and which the developer must ensure do not conflict with any requirements imposed by any applicable laws and standards.

Development works

- 8. The developer shall ensure that all approved works are carried out by appropriately qualified persons and the developer and the persons carrying out and supervising the work shall be responsible for all aspects of the works, including public and worker safety, and shall ensure adequate barricades, signage and other warning devices are in place at all times.
- 9. The developer is responsible for locating and protecting any Council and public utility services, infrastructure and assets that may be impacted on during construction of the development. Any damage to existing infrastructure (kerb, road pavement, existing underground assets, etc.) that is attributable to the progress of works on the site or vehicles associated with the development of the site shall be immediately rectified in accordance with the asset owners' requirements and specifications and to the satisfaction of the asset owners' representative(s).

Amalgamation of Lots

10. The lots comprising the development site (Lot: 6 RP98584, Lot 7: RP98584 and Lot 8: RP98584) must be amalgamated prior to the commencement of the use.

Waste Management

- 11. All waste generated from construction of the premises must be effectively controlled on-site before disposal. All waste must be disposed of in accordance with the *Environmental Protection (Waste Management) Regulation 2000*.
- 12. All waste generated on-site must be managed in accordance with the waste management hierarchy as detailed in the *Waste Reduction & Recycling Act 2011*.

Stormwater Drainage



13. Stormwater drainage is to be provided in accordance with:

a. Queensland urban drainage manual, 3rd Edition, Queensland Department of Energy and Water Supply, 2013;

b. Pilgrim, DH, (ed)., Australian Rainfall & Runoff – A Guide to Flood Estimation, Institution of Engineers, Australia, Barton, ACT, 1987; and

c. Class 1 and Class 10 buildings - National Construction Code, Volume 2.

Earthworks and Construction

14. During construction, erosion controls and silt collection measures are to be put in place to protect environmental values and mitigate potential impacts to adjoining properties and roadway/s.

Avoiding Nuisance

- 15. No nuisance is to be caused to adjoining properties and occupiers by the way of noise smoke, dust, rubbish, contaminant, stormwater discharge or siltation at any time during or after the establishment of the approved development.
- 16. Dust emanating as result of activities carried out onsite must be continually monitored and suppressed in order to prevent any dust drifting onto road networks and nearby properties and sensitive land uses.
- 17. Lighting of the site, including any security lighting, shall be such that the lighting intensity does not exceed 8.0 lux at a distance of 1.5 metres from the site at any property boundary.
- 18. All lighting shall be directed or shielded so as to ensure that no glare directly affects nearby properties.
- 19. The area and its surrounds shall be kept in an orderly fashion, free of rubbish and clear of weeds and long grasses. The approved development and the premises are to be maintained in a clean and tidy condition and not to pose any health and safety risks to the community.
- 20. Noise emissions from the development shall not cause environmental harm of nuisance to adjoining properties or "Sensitive Land Uses" in accordance with the *Environmental Protection* (Noise) Policy 2008.
- 21. Air emissions from the development shall not cause environmental harm of nuisance to adjoining properties or "Sensitive Land Uses" in accordance with the *Environmental Protection (Air) Policy* 2008.
- 22. Unless otherwise approved in writing by the Council, approved hours of construction are restricted to Monday Saturday 6.30am to 6.30pm noise permitted. Work or business which causes audible noise must not be conducted from or on the subject land outside the above times or on Sundays or Public Holidays.



Provision of Services

- 23. The development must be connected to Council's reticulated water supply network in accordance with the applicable standards and policies.
- 24. The development must be connected to Council's reticulated sewerage supply network the applicable standards and policies.
- 25. Proposed buildings located over or near the existing sewer main within the property must be constructed in accordance with 'Queensland Development MP1.4 Building Over or Near Relevant Infrastructure'.
- 26. The development must be connected to an electricity reticulation service in accordance with the relevant service provider's requirements and specifications along with relevant building standards, requirements and specifications (as relevant).
- 27. If the premises is connected to a telecommunications service, then such works shall be undertaken in accordance with the relevant service provider's requirements and specifications along with relevant building standards, requirements and specifications (as relevant).

Access

- 28. The landowner shall be responsible for construction and maintenance of vehicle crossovers from the road carriageway to the property boundary. Should any damage be caused at the approved access location, it is the landowner's responsibility to ensure this is reinstated. Any repair works are to be undertaken in consultation with Council and at the landowner's expense.
- 29. The existing vehicle access points to the development from Beardmore Place shall be upgraded to a concrete standard. The developer will be responsible for the access to be maintained generally in accordance with *Balonne Shire Council's Private Property Entrance Policy* dated 15 January 2010. The design of the vehicle crossovers must cater for the maximum vehicle size accessing the site ensuring no damage to the kerb and channel and roadway.
- 30. Vehicles entering and exiting the development site must be able to enter and leave in forward direction. Reversing out of the development site is not permitted. Vehicle manoeuvres in this regard are to be totally contained within the development site boundaries.
- 31. Vehicle movements within the site are to be clear of proposed parking areas, buildings. Vehicle access, parking and manoeuvring areas are to be clearly delineated from pedestrian access ways within the site through the use of line marking, signage, bollards or similar.

Car Parking

- 32. Car parking and manoeuvring areas are designed in accordance with:
 - a. AS2890.1 Parking Facilities
 - b. Austroads AP-34/95 Design Vehicles and Turning Path Templates
 - c. The Access to Premises Standard' (Vol 1 of the National Construction Code).
- 33. A minimum of six (6) car parking spaces, including one (1) car parking space for persons with



disabilities, are to be provided within the development site area generally in accordance with the approved development plans. Car parking areas must be clearly delineated and/or signposted.

No Cost to Council

34. The developer is responsible for meeting all costs associated with the approved development unless there is specific agreement by other parties, including the Council, to meeting those costs. This includes the costs of any services and infrastructure required in connection with the establishment of the development.

Latest versions

35. Where another condition refers to a specific published standard, manual or guideline, including specifications, drawings, provisions and criteria within those documents, that condition shall be deemed as referring to the latest versions of those publications that are publicly available at the commencement of the development works, unless a regulation or law requires otherwise.

Application Documentation

36. It is the developer's responsibility to ensure that all entities associated with this Development Approval have a legible copy of the Decision Notice, Approved Plans and Approved Documents bearing 'Council Approval'.



ATTACHMENT 2 - PLANNING ACT EXTRACT APPEAL RIGHTS

Chapter 6 Dispute resolution Part 1 Appeal rights

228 Appeals to tribunal or P&E Court

- (1) Schedule 1 states—
 - (a) matters that may be appealed to-
 - (i) either a tribunal or the P&E Court; or
 - (ii) only a tribunal; or
 - (iii) only the P&E Court; and
 - (b) the person-
 - (i) who may appeal a matter (the appellant); and
 - (ii) who is a respondent in an appeal of the matter; and
 - (iii) who is a co-respondent in an appeal of the matter; and
 - (iv) who may elect to be a co-respondent in an appeal of the matter.
- (2) An appellant may start an appeal within the appeal period.
- (3) The appeal period is-
 - (a) for an appeal by a building advisory agency—10 business days after a decision notice for the decision is given to the agency; or
 - (b) for an appeal against a deemed refusal—at any time after the deemed refusal happens; or
 - (c) for an appeal against a decision of the Minister, under chapter 7, part 4, to register premises or to renew the registration of premises—20 business days after a notice is published under section 269(3)(a) or (4); or
 - (d) for an appeal against an infrastructure charges notice—20 business days after the infrastructure charges notice is given to the person; or
 - (e) for an appeal about a deemed approval of a development application for which a decision notice
 has not been given—30 business days after the applicant gives the deemed approval notice to the
 assessment manager; or
 - (f) for any other appeal—20 business days after a notice of the decision for the matter, including an enforcement notice, is given to the person.

Note-

See the P&E Court Act for the court's power to extend the appeal period.

- (4) Each respondent and co-respondent for an appeal may be heard in the appeal.
- (5) If an appeal is only about a referral agency's response, the assessment manager may apply to the tribunal or P&E Court to withdraw from the appeal.



- (6) To remove any doubt, it is declared that an appeal against an infrastructure charges notice must not be about—
 - (a) the adopted charge itself; or
 - (b) for a decision about an offset or refund—
 - (i) the establishment cost of trunk infrastructure identified in a LGIP; or
 - (ii) the cost of infrastructure decided using the method included in the local government's charges resolution.

229 Notice of appeal

- (1) An appellant starts an appeal by lodging, with the registrar of the tribunal or P&E Court, a notice of appeal that—
 - (a) is in the approved form; and
 - (b) succinctly states the grounds of the appeal.
- (2) The notice of appeal must be accompanied by the required fee.
- (3) The appellant or, for an appeal to a tribunal, the registrar must, within the service period, give a copy of the notice of appeal to—
 - (a) the respondent for the appeal; and
 - (b) each co-respondent for the appeal; and
 - (c) for an appeal about a development application under
 - (d) schedule 1, table 1, item 1—each principal submitter for
 - (e) the development application; and
 - (f) for an appeal about a change application under
 - (g) schedule 1, table 1, item 2—each principal submitter for
 - (h) the change application; and
 - (i) each person who may elect to become a co-respondent
 - (j) for the appeal, other than an eligible submitter who is not a principal submitter in an appeal under paragraph (c) or (d); and
 - (k) for an appeal to the P&E Court—the chief executive; and
 - (I) for an appeal to a tribunal under another Act—any other person who the registrar considers appropriate.

(4) The service period is-

- (a) if a submitter or advice agency started the appeal in the P&E Court—2 business days after the appeal is started; or
- (b) otherwise—10 business days after the appeal is started.



- (5) A notice of appeal given to a person who may elect to be a co-respondent must state the effect of subsection (6).
- (6) A person elects to be a co-respondent by filing a notice of election, in the approved form, within 10 business days after the notice of appeal is given to the person.

230 Other appeals

- (1) Subject to this chapter, schedule 1 and the P&E Court Act, unless the Supreme Court decides a decision or other matter under this Act is affected by jurisdictional error, the decision or matter is non-appealable.
- (2) The Judicial Review Act 1991, part 5 applies to the decision or matter to the extent it is affected by jurisdictional error.
- (3) A person who, but for subsection (1) could have made an application under the Judicial Review Act 1991 in relation to the decision or matter, may apply under part 4 of that Act for a statement of reasons in relation to the decision or matter.
- (4) In this section-

decision includes-

- (a) conduct engaged in for the purpose of making a decision; and
- (b) other conduct that relates to the making of a decision; and
- (c) the making of a decision or the failure to make a decision; and
- (d) a purported decision; and
- (e) a deemed refusal.

non-appealable, for a decision or matter, means the decision or matter—

- (a) is final and conclusive; and
- (b) may not be challenged, appealed against, reviewed, quashed, set aside or called into question in any other way under the Judicial Review Act 1991 or otherwise, whether by the Supreme Court, another court, a tribunal or another entity; and
- (c) is not subject to any declaratory, injunctive or other order of the Supreme Court, another court, a tribunal or another entity on any ground.

231 Rules of the P&E Court

- (1) A person who is appealing to the P&E Court must comply with the rules of the court that apply to the appeal.
- (2) However, the P&E Court may hear and decide an appeal even if the person has not complied with rules of the P&E Court.



ATTACHMENT 3 — STATEMENT OF REASONS


The following information is provided in accordance with section 63 of the Planning Act 2016.


Description of Development	Material Change of Use – "Community Use"
Assessment benchmarks	The proposed development was assessed against the following Assessment benchmarks: Maranoa-Balonne Regional Plan; Darling Downs Regional Plan; State Planning Policy; and Balonne Shire Planning Scheme 2019 Part 4 Local Government Infrastructure Plan Part 5 Tables of assessment Part 6 Zones Part 6.2.1 Centre zone code Part 7 Development Codes Part 7.3.1 General development code
Relevant matters	The relevant matters are the Assessment benchmarks.
Matters raised in submissions	Not Applicable.
Reasons for decision	The development was assessed against all of the Assessment benchmarks listed above and complies with all of these Assessment benchmarks or has otherwise been conditioned to achieve compliance.





ATTACHMENT 4 — APPROVED PLANS AND SPECIFICATIONS



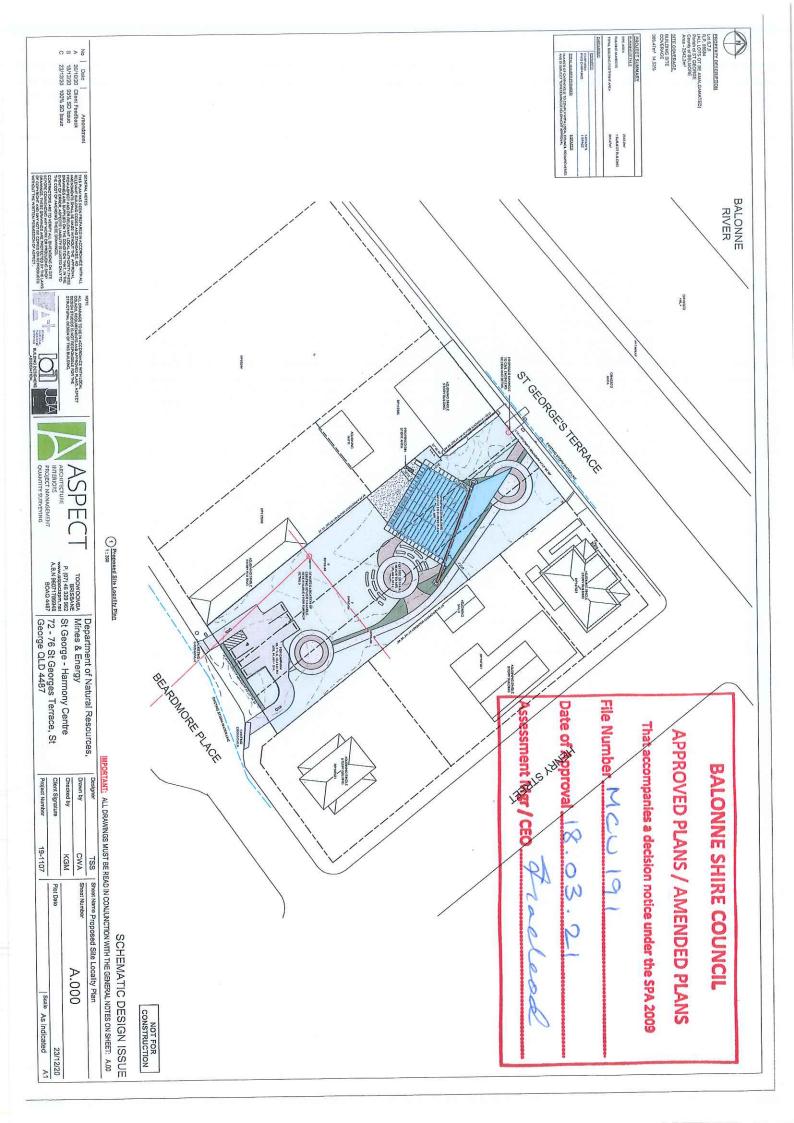

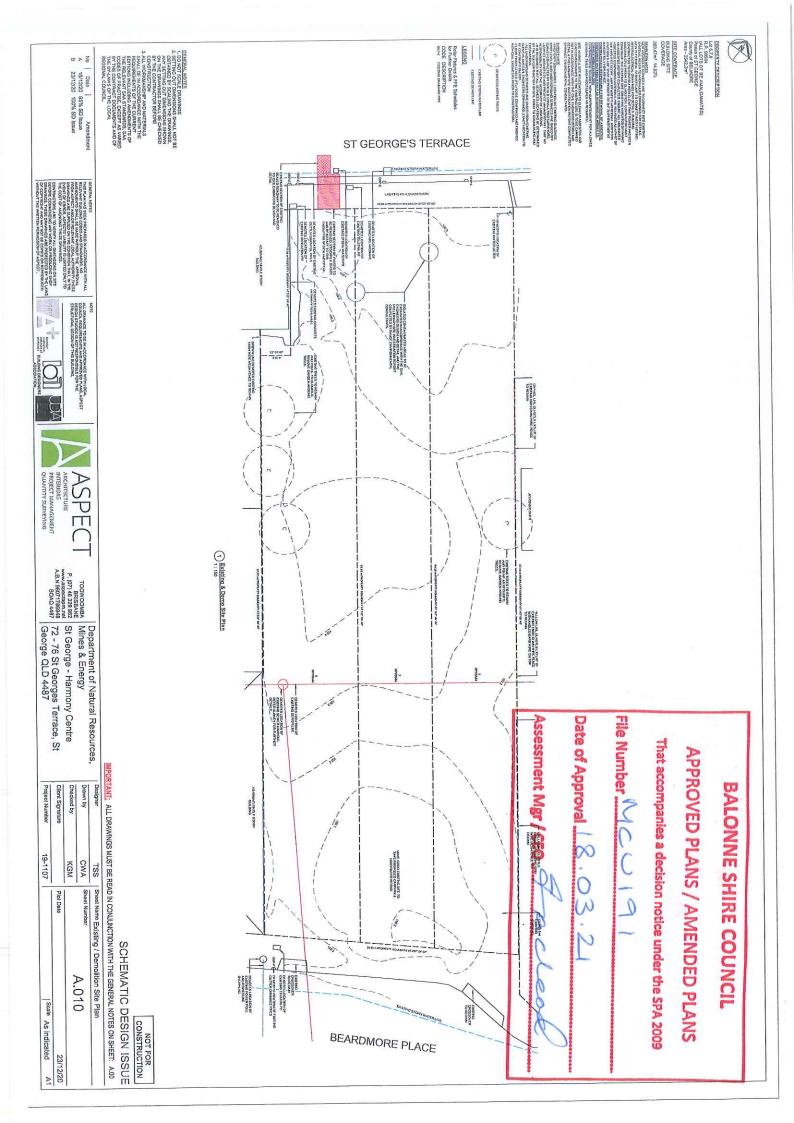

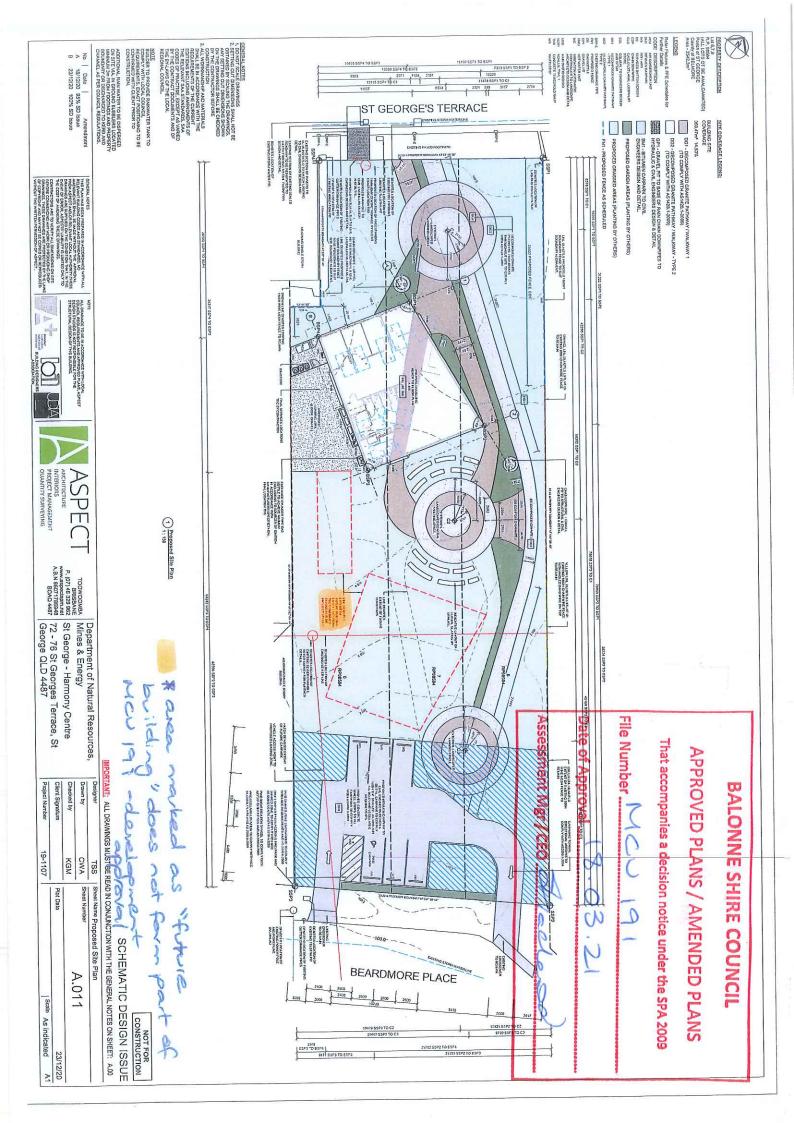

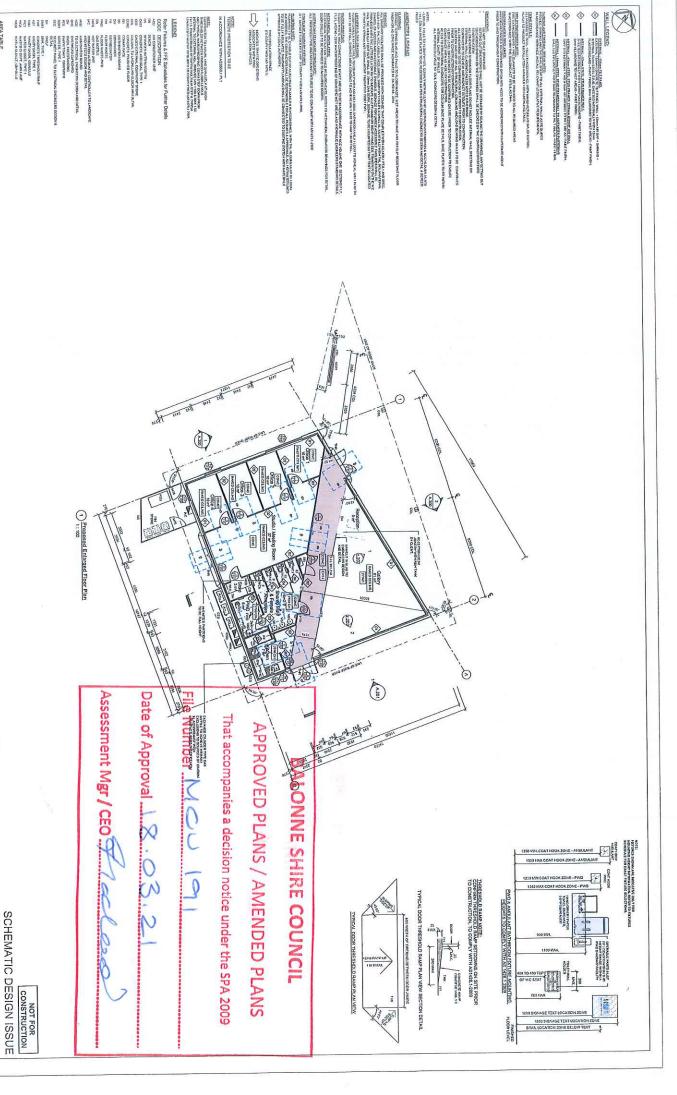

AREA TABLE

220.25 m²

to Date Amendment
A 26/10/20 Client Feedback
B 18/12/20 95% SD Issue
C 23/12/20 100% SD Issue

A 23 Brokers

PROJECT MANAGEMENT QUANTITY SURVEYING **ASPEC**

Toowoonals Research Mines & Energy Right St. George - Harmony Centre ALN 8607/198844 72 - 76 St Georges Terrace, St George QLD 4487

Drawn by

CWA

Client Signature Project Number

19-1107

Scalo As indicated


23/12/20

Plot Date

MPORTANT: ALL DRAWINGS MUST BE READ IN CONJUNCTION WITH THE GENERAL NOTES ON SHEET: A.00

Sheet Name Proposed Floor Plan

A.100

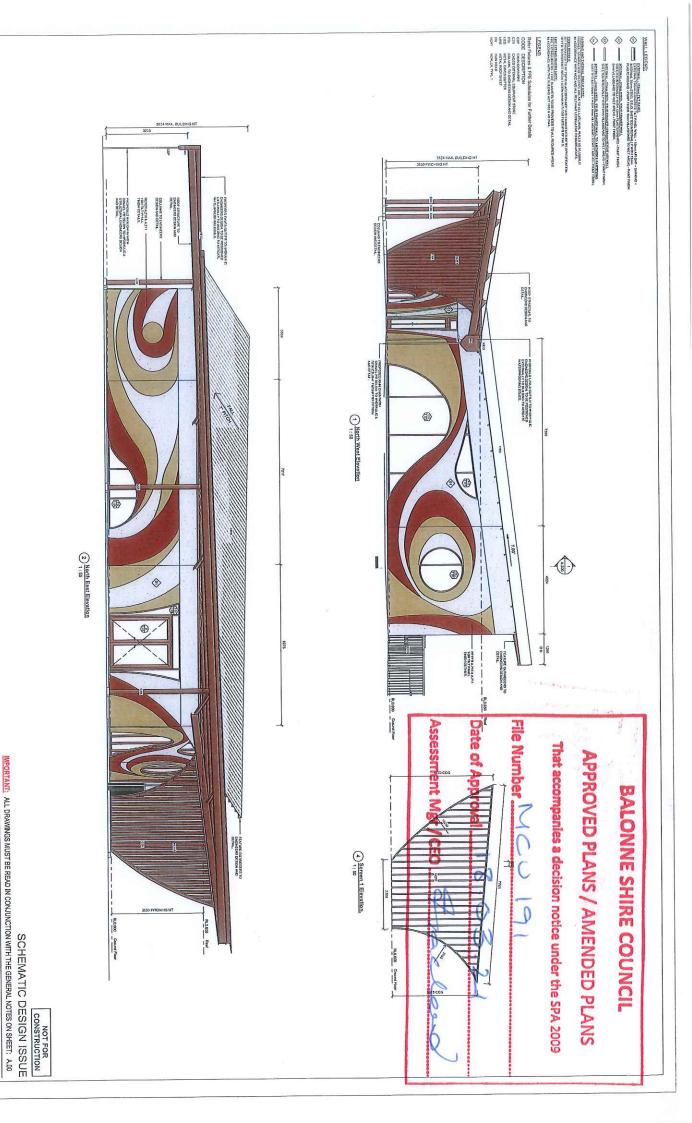

B > No

Date | Amondment 18/12/20 95% SD Issue 23/12/20 100% SO Issue

A Streets Application Sections Du

ASPEC

Towwoowled BRISEAUE P. (07) 46 2329 82 Wines & Energy P. (07) 46 2329 82 St George - Harmony Centre www.apperterm.int 72 - 76 St Georges Terrace, St George QLD 4487

Checked by Client Signature

> TSS CWA

Sheet Number


Sheet Name Proposed Elevations

Project Number

19-1107

23/12/20 Scale As indicated A1

PROJECT MANAGEMENT QUANTITY SURVEYING

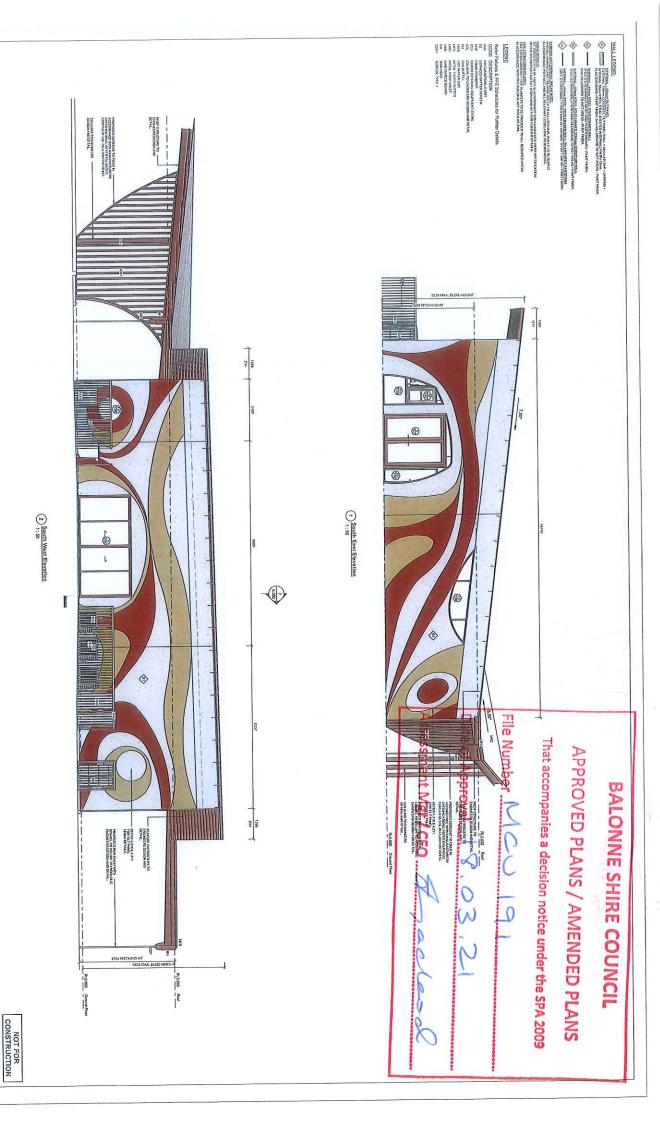

No | Date | Amendment A 18/12/20 95% SD Issue B 23/12/20 100% SD Issue

ALL DRAINAGE TO BE IN ACCORDANCE WITH LOCAL COUNCIL REQUIREMENTS AND APPROVED PLANE. ADPECT DESIGN STUDIES IS NOT RESPONSIBLE FOR THE STRUCTURAL DESIGN OF THIS BUILDING.

ASPEC

Trocwoonwah RISBANE P. (7) A STATE PROPERTY P. (7) A STATE S

Drawn by

TSS CWA KGM

Sheet Number

A.201

Client Signature Project Number

19-1107

Scale As indicated

23/12/20 Ited A1

Plot Date


Designer


MPORTANT: ALL DRAWINGS MUST BE READ IN CONJUNCTION WITH THE GENERAL NOTES ON SHEET: A.00


SCHEMATIC DESIGN ISSUE


Sheet Name Proposed Elevations

A To Manager Builto

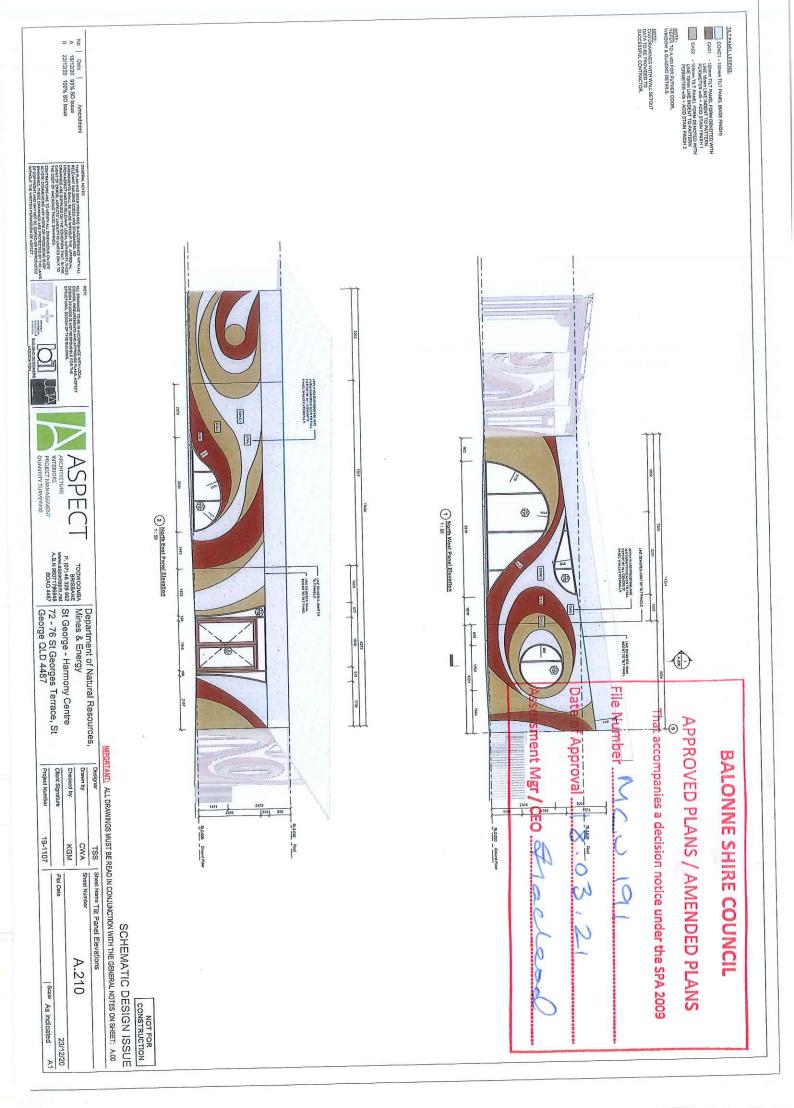

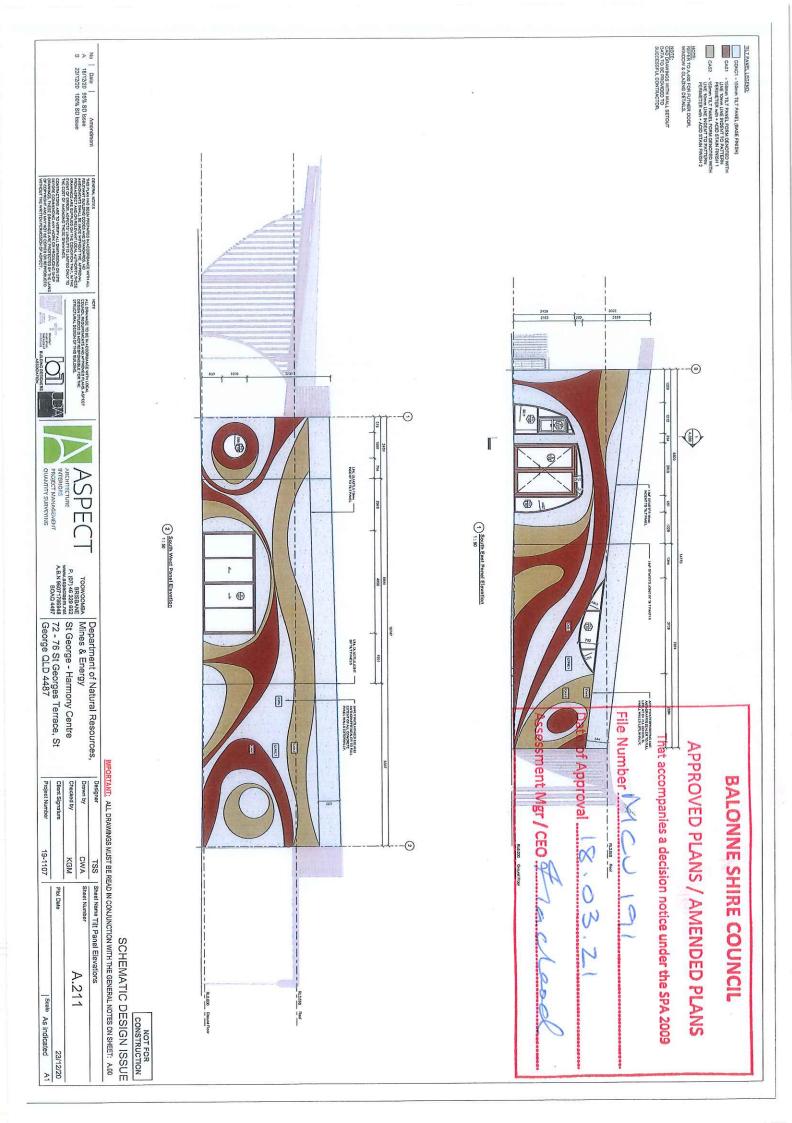

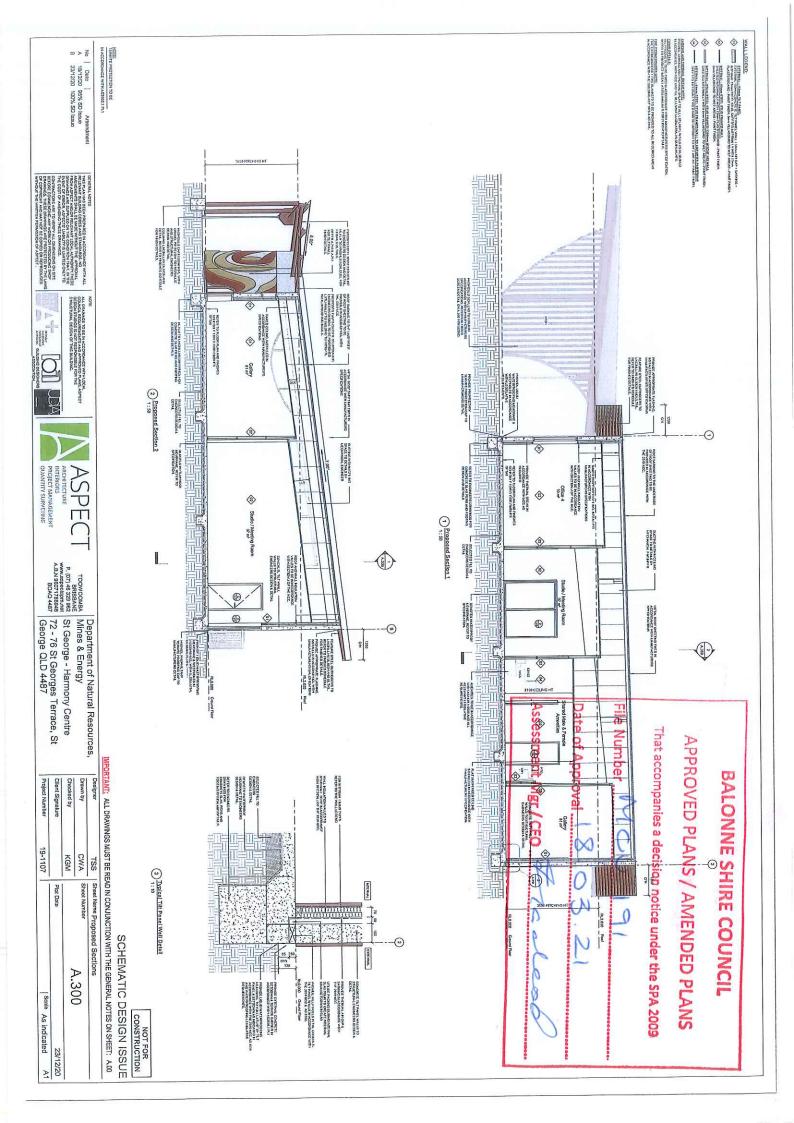

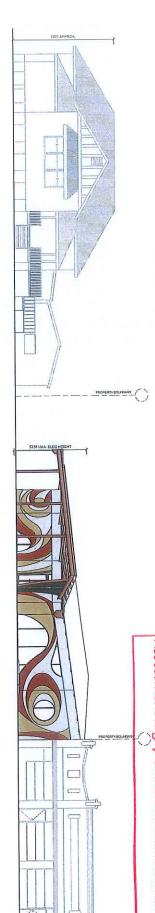

St George Terrace Streetscape Elevation 1: 100

BALONNE SHIRE COUNCIL

APPROVED PLANS / AMENDED PLANS

That accompanies a decision notice under the SPA 2009

File Number 1200

Date of Approval 18.03

Assessment Mgr / CEO

NOT FOR CONSTRUCTION

SCHEMATIC DESIGN ISSUE

ASPEC

6 × 8

Date Amendment 18/12/20 95% SD Issue 23/12/20 100% SD Issue

Andrian BULDING DESIDATES

TOOWOOMBA RISBANE P.,070 46 323 962 St George - Harmony Centre www.appentpm.md 72 - 76 St Georges Terrace, St George QLD 4487

Drawn by Client Signature Project Number Checked by 19-1107 TSS KGM Sheet Name Proposed Streetscape Elevation Plot Date A.250 Scale

23/12/20 1:100 A1

File Number That accompanies a decision notice under the SPA 2009 APPROVED PLANS / AMENDED PLANS Approval 18,03 **BALONNE SHIRE COUNCIL** Mgr/CEO

1) External 3D Perspective 1



2 External 3D Perspective 2

PROJECT MANAGEMENT QUANTITY SURVEYING **ASPEC**

Toowcooked Brisewic F. (17) 45 Terror of Natural Resources, Brisewic F. (17) 46 329 982 St George - Harmony Centre www.appediam.na. 98077 78844 72 - 76 St George S Terrace, St George QLD 4487

Drawn by

Designer

IMPORTANT: ALL DRAWINGS MUST BE READ IN CONJUNCTION WITH THE GENERAL NOTES ON SHEET: A.00 TSS | Sheet Name Perspectives SCHEMATIC DESIGN ISSUE

NOT FOR CONSTRUCTION

Client Signature Project Number 19-1107 CWA MOX Plot Date Sheet Number A.900 Scale 23/12/20

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1 External 3D Perspective 3 Date of Approval 18.03 File Number 1300 That accompanies a decision notice under the SPA 2009 PLANS / AMENDED PLANS NNE SHIRE COUNCIL NOT FOR CONSTRUCTION

26/10/20 Client Feedback 18/12/20 95% SD Issue 23/12/20 100% SD Issue

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PROJECT MANAGEMENT QUANTITY SURVEYING **ASPEC**


Tropwoowlea Bristavie P.,(07) 46 239 862 Www.aspoetism.md. A.B. 9807/198848 T2 - 76 St George - Harmony Centre Ceorge QLD 4487

2 External 3D Perspective 4

SCHEMATIC DESIGN ISSUE

MPORTANT: ALL DRAWINGS MUST BE READ IN CONJUNCTION WITH THE GENERAL NOTES ON SHEET: A.00

Client Signature Checked by Drawn by Project Number 19-1107 CWA KGM TSS Shoot Name Perspectives Sheet Number Plot Date A.901 Scalo 23/12/20

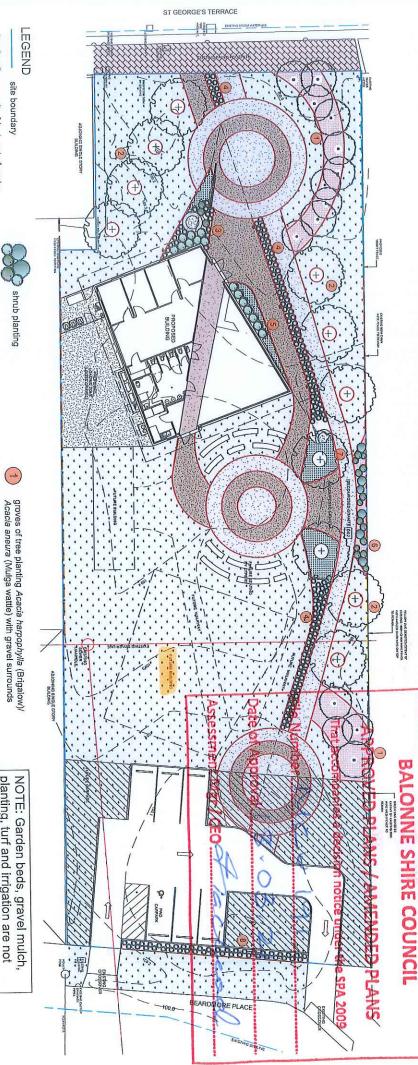

grass/turf (not part of works,

to be completed by client) option 1 - steel garden edge option 2 - plastic garden edge not part of works. To be

groundcover planting

Note: Planting works are not part of the works. These will be completed by the client)

completed by client)



















water connection for irrigation gravel surround to trees/planting (not part of works. To be completed by client)

> (5) 4 (w)

(O)



provided to all garden areas. Water to be piped via subsurface Dripline irrigation to be completed by the client) part of the works. These will be pipe between gardens & trees. Note: Irrigation works are not

(Chinchilla White gum)

Eucalyptus argophloia

groves of tree planting

Acacia harpophylla (Brigalow)

Acacia aneura (Mulga wattle)

MENDMENTS Une Date Details
17,12,20 draft for
17,12,20 draft for
17,12,20 draft for
04,01,21 amende draft for client review
or draft for client review
amended as per lates


tree planting



N

shade tree planting with Eucalyptus argophloia (Chinchilla White gum) groves of tree planting Acacia harpophylla (Brigalow)/ Acacia aneura (Mulga wattle) with gravel surrounds



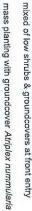



to provide screen to adjacent property clumps of shrub planting with gravel between

shade tree planting with Eucalyptus argophloia (Chinchilla White gum) with groundcover Eremophila 'Kalbarri Carpet'

mass planting with groundcover Atriplex nummularia (Saltbush)

(00)

planting, turf and irrigation are not completed by the client. part of the works. These items will be

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A K K Aspect CLIENT St George Harmony Centre 94 The Terrace, St George Old Schematic Design Landscape Plan 2006-01 DRAWING DRAWING NO DATE January 2021 A DRAWN




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6,25

46 Skehan Street Centenary Heights Q 4350 0427 667748 jamosla@bigpond.net.au





NORTH WEST ELEVATION scale 1:100 @ A3

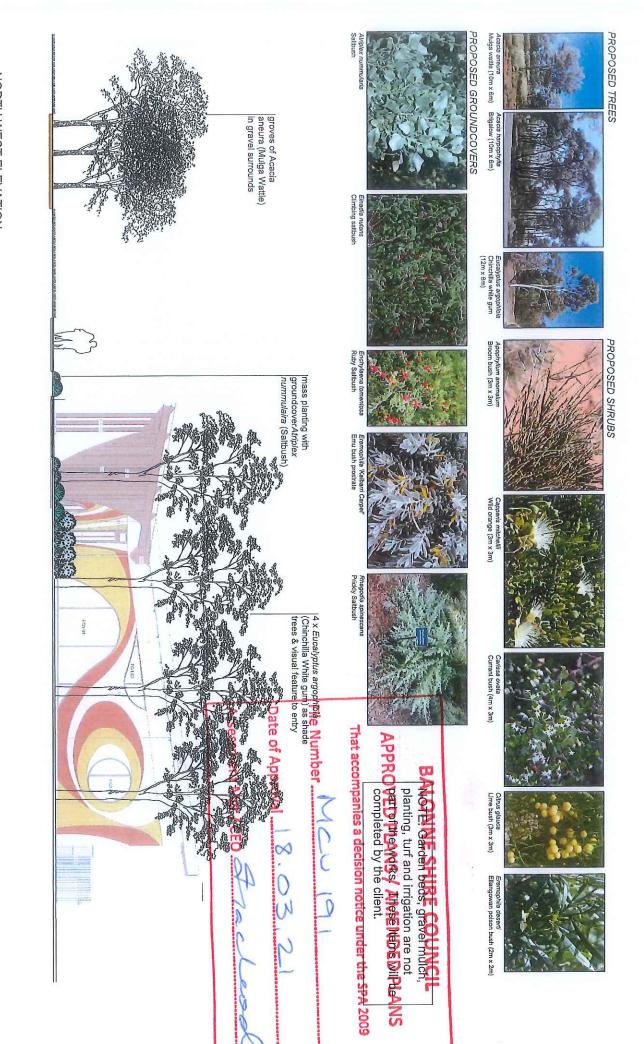C Jackle Ames Landscape Architect 2020

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Aspect	CLIENT	94 The Terrace, St George Q		PROJECT
2006-02	DRAWING NO.	Proposed Plants & Elevation	Schematic Decion	DRAWING
January 2021	DATE	JA	The second secon	DRAWN
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Jackle Amos Landscape Architect
46 Skehan Street
Centenary Helgils C. 4350
0427 667748
jamosla@blgpond.net.au

EROSION AND SEDIMENT CONTROL NOTES

- . THE CONTRACTOR SHALL ENSURE THAT MUD AND SILT IS NOT TRACKED ONTO PUBLIC ROADS BY VEHICLES LEAVING THE SITE
- 2. A REPRESENTATIVE OF THE CONTRACTOR SHALL BE ON SITE AT ALT THIS DIGHNOR AND CONSENCUTION DEFAULTORS AND SHALL RECTIFY AND FAMILURE OF THE SUIT CONTROL DEVICES AND CLEAN AND FATENNAL ROADS CONTAMINATED BY CONSTRUCTION TRAFFIC.
- INSPECTION OF THE SURROUNDING ROADWAYS SHALL BE CARRIED OUT ON A DAILY BASIS AND A DIARY RECORDS KEPT WITH RESPECT TO ANY CLEANING WORKS UNDERTAKEN.
- L SUBCONTRACTORS SHALL NOT BE ALLOWED TO WORK UNSUPERVISED.
- 5. DUST EMISSIONS FROM CONSTRUCTION MACHINERY SHALL BE CONTROLLED BY REGULAR WATERING OR ON AN AS-REQUIRED CONTROLLED BY REGULAR WATERING OR ON AN AS-REQUIRED
- 6. SILT STOP FENCES SHALL BE INSTALLED AT THE START OF WORKS AND SHALL BE MAINTAINED FOR THE FULL DURATION OF THE PROJECT AND UNTIL ESTABLISHMENT OF ANY PLANTINGS.

EARTHWORKS NOTES

- PRIOR TO THE COMMENCEMENT OF WORKS THE CONTRACTOR IS TO CONFIRM THE LOCATION OF ALL UNDERGROUND SERVICES AND SET OUT DIMENSIONS.
- 2. ALL WORKS SHALL BE IN ACCORDANCE WITH AS3798 GUIDELINES ON EARTHWORKS FOR COMMERCIAL AND RESIDENTIAL DEVELOPMENT.
- SECTIONS OF EXISTING CONCRETE SLAB TO BE REMOVED AND DISPOSED OF OFF SITE INCLUDING EXCESS MATERIAL, FENCING AND VEGETATION.

- A FIELD DENETY TESTING OF THE FILL SHALL BE CARRED OUT AND THE RESULTS
 AREITO BE SUBMITTED TO THE ENGINEER FOR APPROVAL TESTING SHALL BE NOT
 LESS THANK
 LESS THANK
 1-4 TESTS AS DIRECTED IN THE NATURAL SUBGRADED
 4 TESTS AS DIRECTED DEVENLY DISTRIBUTED THROUGHOUT THE DEPTH OF THE
 LITE PLATFORM.

- 3. THE WHOLE OF THE SITE AREA AFFECTED BY EARTHWORKS IS TO BE STIPPED OF WIN. 10mm THICKNESS OF TOPSOIL AND ORGANIC MATTER. TOPSOIL IS TO BE STOCKPILED FOR REJUSE IN LAUDISCAPED AREAS AS DIRECTED ON SITE. THE REMAINING TOPSOIL SHALL BE REMOVED FROM SITE.
- AFTER STRIPPING AND/OR CUTTING THE SITE, THE SUBGRADE IS TO BE PROOF
 ROLLED IN THE PRESENCE OF THE ENGINEER TO REVEAL ANY SOFT SPOTS WHICH
 ARE TO BE REMOVED. THESE TO BE REMOVED SHALL BE GRUBBED OUT AND
 BACKFILLED WITH APPROVED SELECTED MATERIAL.
- E THE BUILDING PLATFORM SHALL BE PREPARED BY CUTTING AND FILLING THE NATURAL MATERIAL TO THE PETERS AND THE EXTENDING AND FILLING THE PLATFORM LOCAL REQUIRED SHALL BE APPROVED DESIGN LEVELS. ADDITIONAL FILL MATERIAL FROUNDED SHALL BE APPROVED IMPORTED FILL MATERIAL OF MAY, HE 25% AS LATERNATIVELY. APPROVED OURSY SCALPING MATERIAL OF MAY, SOAKED DERIG, PLATSW AND DAX. AGGREGATE SIZE OF 75mm. SAMELES WITH PRODUCE SPECIFICATION LIMITS ARE TO BE SUBMITTED TO THE ENGINEER FOR APPROVAL PRIOR TO ARRIVAL ON SITE.
- 7. FILL SHALL BE PLACED IN MAXIMUM 150mm LAYERS AND COMPACTED TO 38% STANDARD COMPACTION IT OS 1289. COMPACTION IS TO BE 35% OF DEPIMUM MOISTURE CONTROL THE COMPACTION IS TO BE 15% OF DEPIMUM MOISTURE CONTROL THE CHAINER THE FINAL LAYER SHALL BE TRANSCO PRIOR TO PLACEMENT OF SLAB BEDDING BEDDING MATERAL IS TO BE TANDON FOR TO PLACEMENT OF SLAB BEDDING BEDDING MATERAL IS TO BE MAINTAINED DURING COMPACTED THICKNESS. ADEQUATE SITE DRAINAGE IS TO BE MAINTAINED DURING COMPACTED THICKNESS.
- 8. ISOLATED CONTAMINATION AREAS INDICATED TO BE EXCAVATED A MINIMAM 1m RADIUS TO A MINIMAM DEPTH OF DAM DEEP, SOIL SHOULD BE STOCKPILED ON HEAVY DUTY BLACK PLASTIC OF PRACED DIRECTLY INTROCKO RBIN AND MAX MIXED WITHOUTHER SOILS. EXCAVATED MATERIAL FROM THE REMEMBER THAN AREA REGULATED WAS THE REMEMBER THAN AREA CONTRACTOR. CONTRACTOR TO HARBOT SEES DATE HOWATTON SOIL SAMPHING AT BOTH CONTRACTOR. CONTRACTOR TO HARBOT SEES OF THE REMEMBER WORKS TO THE REMEMBER WORKS TO THE REMEMBER OF SOIL SAMPHING AT BOTH CONTRAINS STORE REPORTED HEAD AND SEES OF THE REMEMBER WORKS TO CONTRAINS STORE REPORT OF THE REMEMBER WORKS TO THE REMEMBER OF THE REMEMBER OF

PAVEMENT NOTES

- REFER EARTHWORKS NOTES FOR PREPARATION TO SUBGRADE LEVEL
- SUBGRADE SHALL BE COMPACTED TO 98% STANDARD COMPACTION TO AS1289 AND PROOF ROLLED BY A MINIMUM BT TRUCK IN THE PRESENCE OF THE ENGINEER SOFT SPOTS ARE TO BE REMOVED AS DETERMINED BY THE ENGINEER AND REINSPECTED UPON REINSTATEMENT.
- FINISHED SUB-GRADE TO CARPARK AREA, SHALL BE TESTED TO CONFIRM THE CBR OF THE FINISHED SUB-GRADE MATERIAL, CBR RESULTS TO BE FORWARDED TO THE ENGINEER TO CONFIRM THE DEPTH OF PAVEMENT MATERIAL REQUIRED.
- PAYEMENT MATERIAL SHALL BE MINIMUM MED SUBTYPE 23 MODIFED (CERD) GRADING AND COMPACTED IN MAXIMUM STORM. LAYERS TO 100% STRANDARD COMPACTION TO AS 228, PROOF ROLLING AS SPECIFED FOR SUBGRADE SHALL BE CONDUCTED IN THE PRESENCE OF THE ENGINEER, ACCEPTANCE AND ANY RECONSTRUCTION SHALL BE AS DIRECTED BY THE ENGINEER.
- 5. PAVEMENT SPECIFICATION:-DRIVEWAYS AND CARPARKS:

250mm ROADBASE PAVEMENT (EQUAL BASE & TOP COURSES)

- E, PAVEMENT SPRAY SEAL, IF REQUIRED

 6.1. HOURS PRIOR TO:
 6.2. INCLUSE PRIOR TO:
 6.2. INCLUSE PRIOR TO:
 6.3. AGGREGATE 10 mm (PRE CONTED) @ 1 m³ (100 PRAY RATE 1.2 Lm³) COVER
 6.3. AGGREGATE 10 mm (PRE CONTED) @ 1 m³ (100 PRAY RATE 1.0 Lm³) COVER
 6.3. AGGREGATE 10 mm (PRE CONTED) @ 1 m³ (100 PRAY RATE 1.0 Lm³) COVER
 6.4. AGGREGATE 1 mm (PRE CONTED) @ 1 m³ (100 m³)

7. PAVEMENT TESTING:
SUBGRADE: 1 N° INSITU DENSITY TEST PER 150m²
PAVEMENT: 1 N° INSITU DENSITY TEST PER 150m²

LINEMARKING NOTE:

PROVIDE TODM WIDE WHITE LINEWARKING TO CARPARY SPACES WHEER LINEWARKING TO CARPARY SPACES WHEER LINEWARK SPACE AND STARES AND LINE CARPARY SPACE AND STARES AND STALLAR SPACE AND STALLAR SPACE







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RESOURCES, MINES & ENERGY DEPARTMENT OF NATURAL

ST GEORGE HARMONY CENTRE 72-76 ST GEORGE'S TERRACE, ST GEORGE, QLD 4487

Date of Approval 18,03,2

File Number

9

That accompanies a decision notice under the SPA 2009

APPROVED PLANS / AMENDED PLANS

BALONNE SHIRE COUNCIL

NOTE: FULL DEPTH CUT JOINTS TO BE INSTALLED THROUGH THE KERS AND CHANNEL AT MAX 30m CTS AT TIME OF CONSTRUCTION. STAND-UP - TYPE A

110 40 300

- ASPHALT THICKNESS
- PAVEMENT DEPTH

SCHEMATIC DESIGN SITE CIVIL WORKS LAYOUT - NOTES AND DETAILS


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P2 23,12.20 100% SD ISSUE Pt 16.12.20 CO-ORDINATION ISSUE

PRELIMINARY NOT FOR CONSTRUCTION




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DEPARTMENT OF NATURAL RESOURCES, MINES & ENERGY

ST GEORGE HARMONY CENTRE 72-76 ST GEORGE'S TERRACE, ST GEORGE, QLD 4487

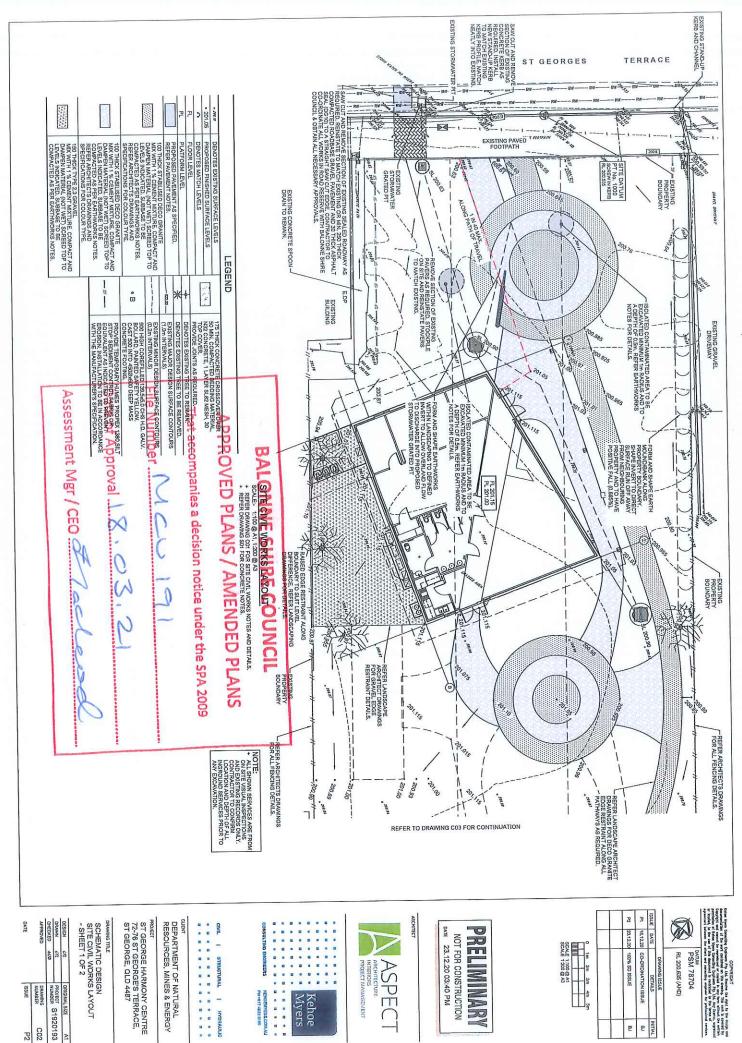
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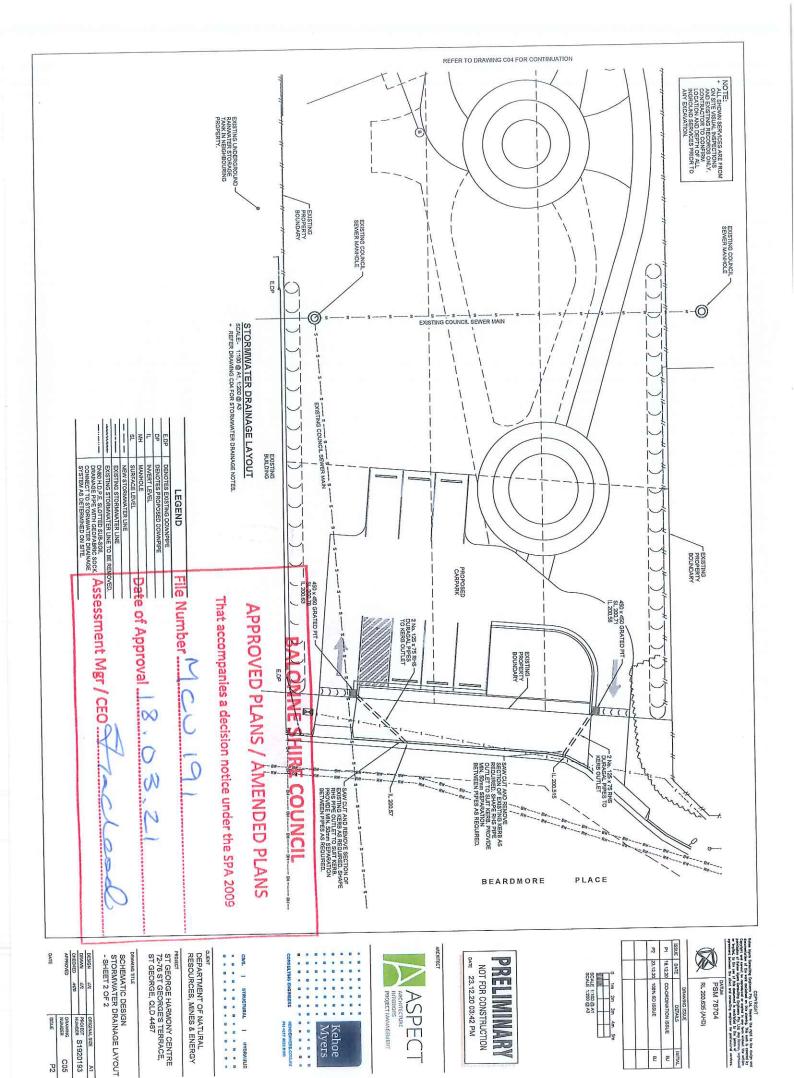
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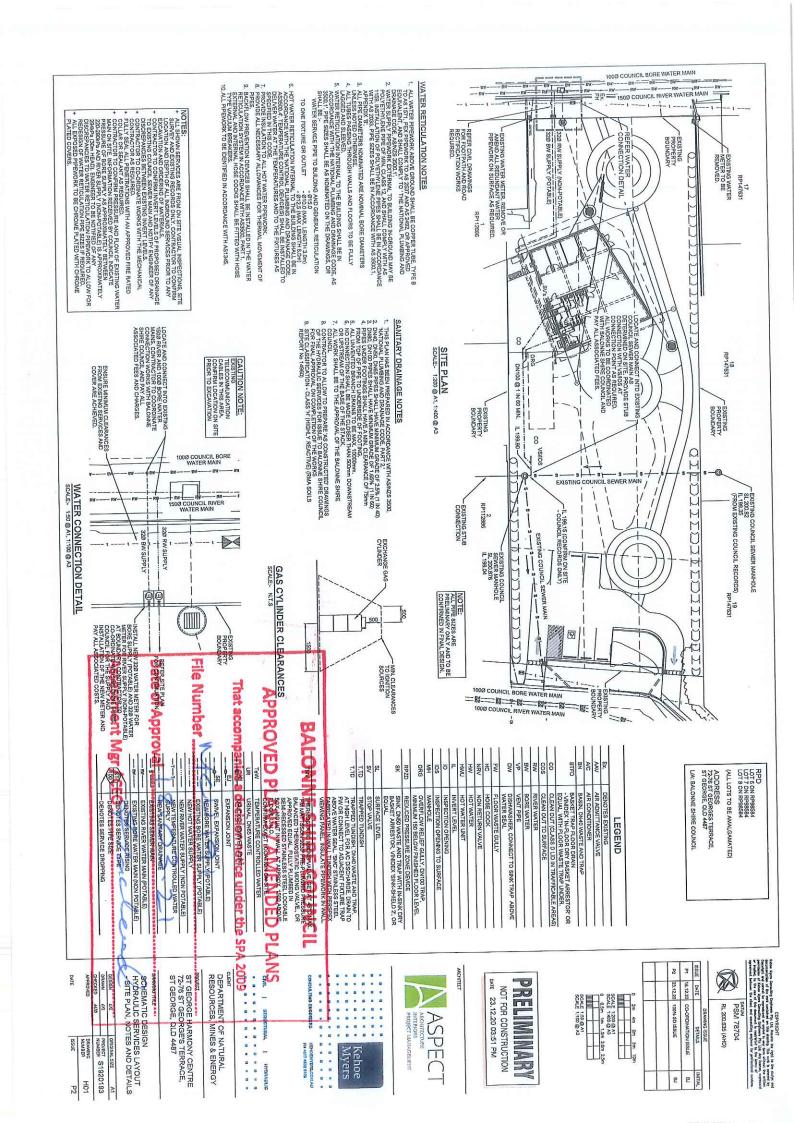
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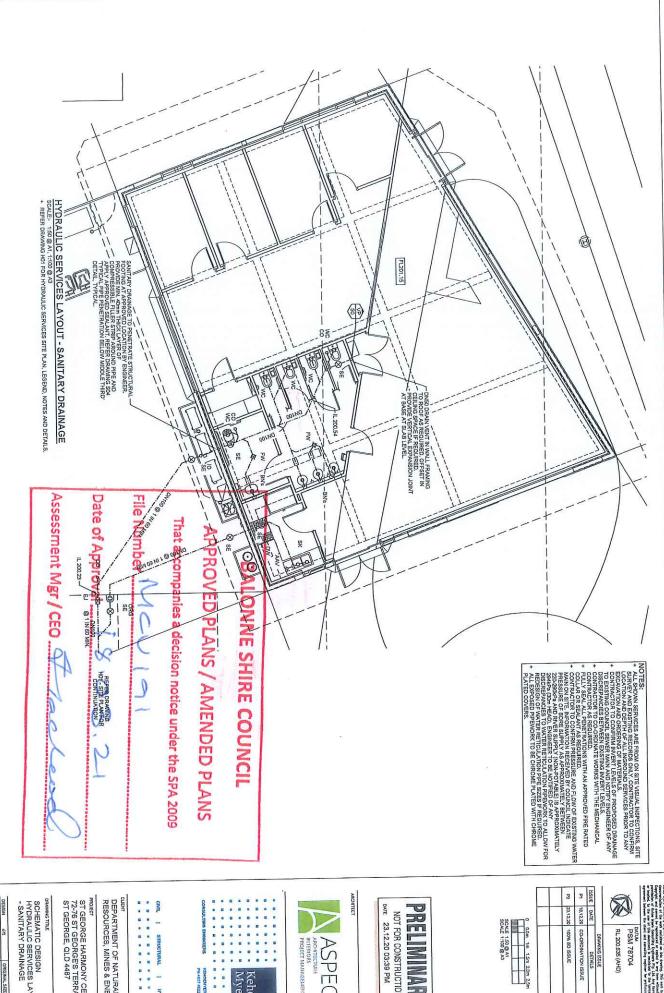
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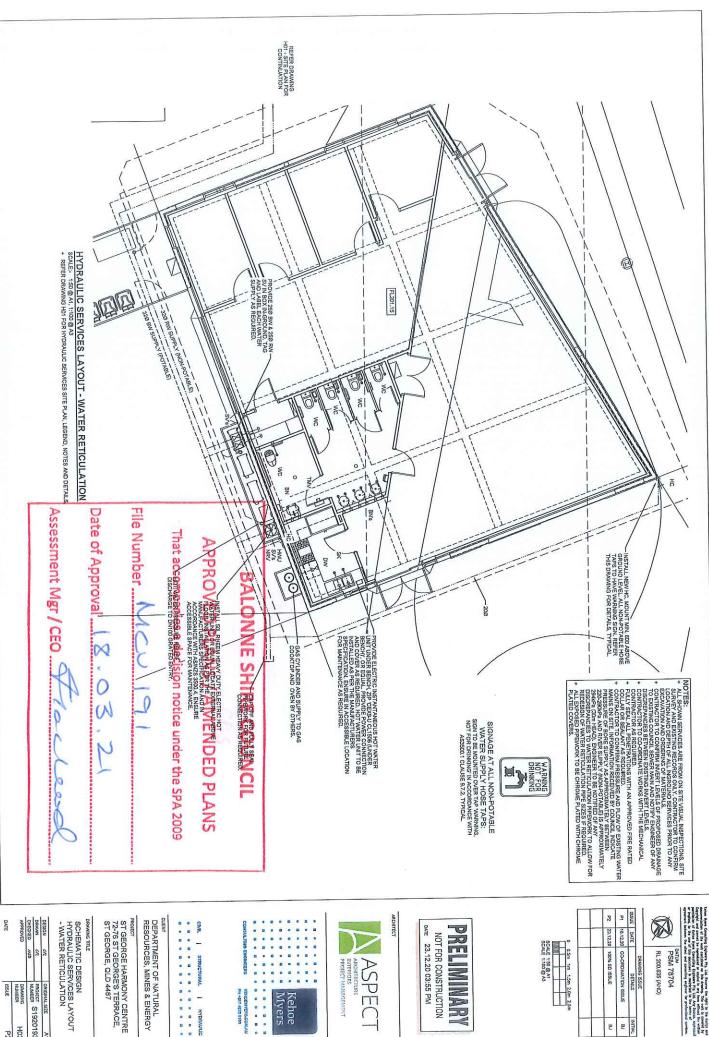
ST GEORGE HARMONY CENTRE 72-76 ST GEORGE'S TERRACE, ST GEORGE, QLD 4487

SCHEMATIC DESIGN HYDRAULIC SERVICES LAYOUT - SANITARY DRAINAGE

DRAWING NUMBER ISSUE NUMBER S1920193 H02

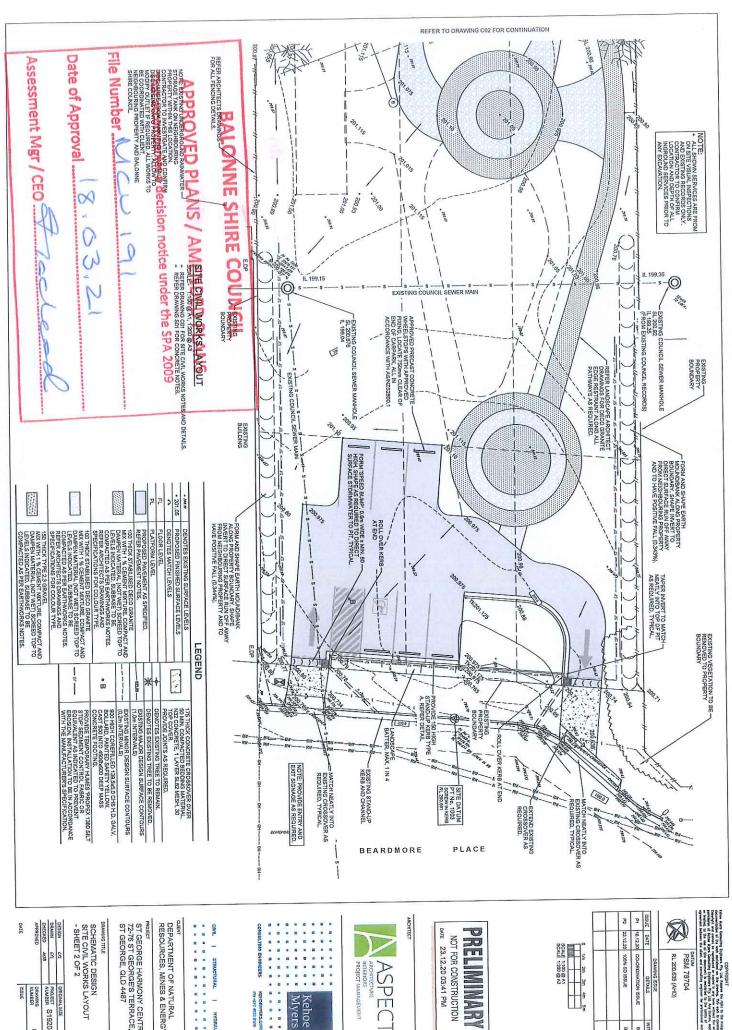DATE

DEPARTMENT OF NATURAL RESOURCES, MINES & ENERGY PRELIMINARY NOT FOR CONSTRUCTION ASPEC PROJECT MANAGEMENT Kehoe Myers

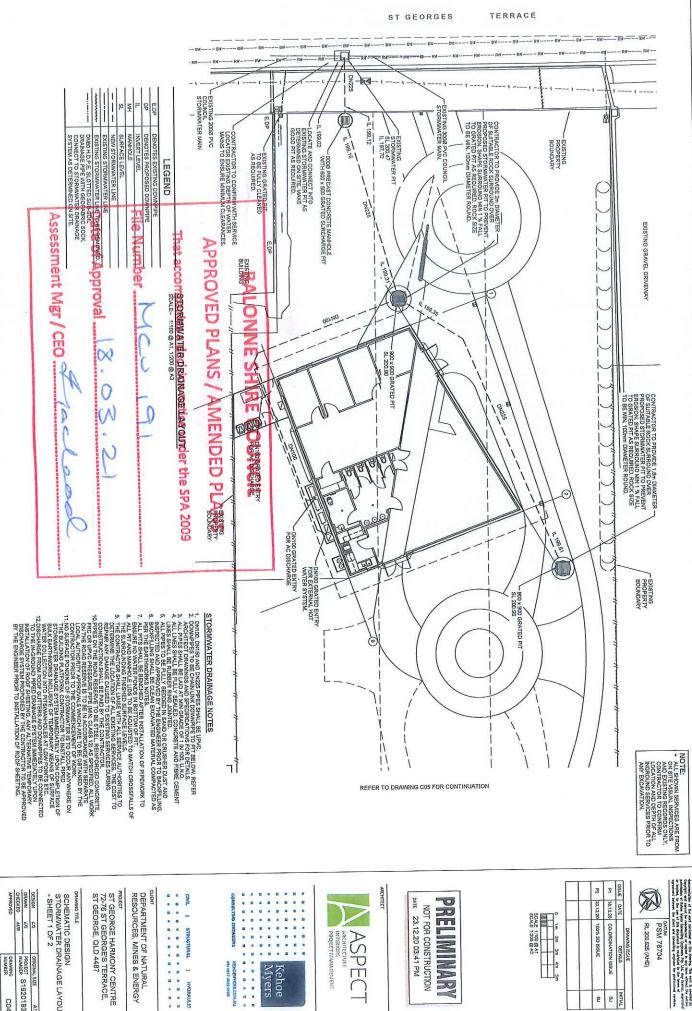

NOT FOR CONSTRUCTION ASPECT


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GENERAL NOTES

1. THESE DRAWNIGS ARE TO BE READ IN COMUNICTION WITH ALL
CONSULTANTS DRAWNIGS AS APPLICABLE AND THE SPECIFICATION.

- ALL SET OUT DIMENSIONS SHALL BE CONFIRMED ON SITE PRIOR TO COMMENCEMENT OF WORK, CIMENSIONS SHALL NOT BE OSTAINED BY SCALING FROM THE DRAWING, REFER TO ENGINEER FOR DECISION IF ANY DISCREPANCIES EXIST.
- 4, ALL WORKMANSHIP AND MATERIALS SHALL BE IN ACCORDANGE WITH THE REQUIREMENTS OF CURRENT SAA STRANDARDS AND CODES OF PRACTICE (EXCEPT AS VARIED BY THE CONTRACT DOCUMENTS) AND OF THE LOCAL AUTHORITY. WORK AS DETAILED ON THE DRAWINGS SHALL NOT BE VARIED WITHOUT THE PRIOR WRITTEN CONSENT OF THE ENGINEER.
- 5. THE CONTRACTOR SHALL MANITAIN THE STRUCTURE IN A STABLE CONDITION DURING CONSTRUCTION, NO STRUCTURAL ELEMENTS SHALL BE OVERSTRESSED BY CONSTRUCTION LOADINGS.
- 6. THE STRUCTURE HAS BEEN DESIGNED FOR THE FOLLOWING LOADS IN ACCORDANCE WITH ASNESS 1170 SAA LOADING CODE:
 WINDLOAD WINDLOAD
- TERRAIN CATEGORY
 Ms = 1,0 Mt = 1,0
 AS1684,2 WIND CLASSIFICATION

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ROOF FLOOR

FOUNDATION NOTES

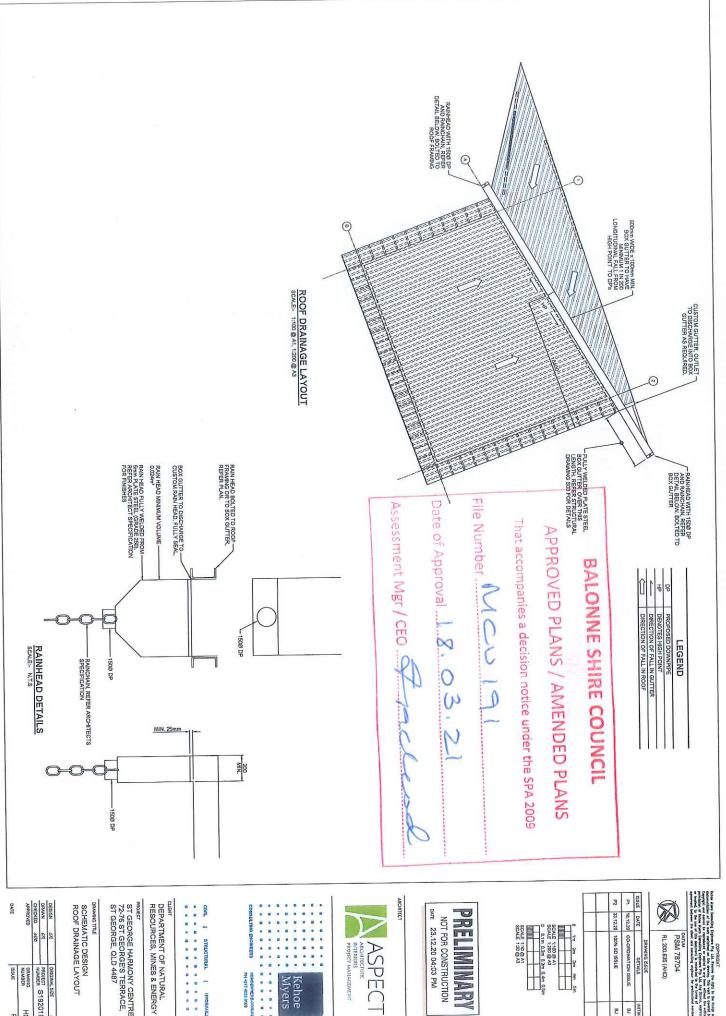1. COOTINUS HAVE BEEN DESIGNED FOR AN ALLOWABLE BEARING
1. CHACHTY OF TOURH FOUNDING MITTON LATER LAND SANDY SITTY CLAY
MITCHAL (REFER GEOTECHNICAL REPORT No. 1485 DY RIM. SOILS THE
ENVIRONTON MATERIAL IS TO BEAPROVICED BY THE SUNNIERE FOR THIS
BEARING CAPACITY BEFORE PLACING REINFORCEMENT OR CONCRETE.

- FOOTINGS SHALL BE LOCATED CENTRALLY UNDER WALLS AND COLUMNS U.N.O.
- 3. FOOTINGS TO BE CONSTRUCTED AND HAVE CONCRETE PLACED AS COON AS POSSIBLE FOLLOWING EXCAVATION TO AVOID SOFTENING OR DRYING BY EXPOSURE.
- EXCAVATIONS SHALL BE KEPT FREE OF PONDED WATER BEFORE PLACING CONCRETE.
- 5. TO ENSURE THAT THE MOISTURE CONTENT OF THE SOIL REMAINS REASONABLY SYMALE AND HENCE UNIT GROUND MOVEMENTS. THE GROUND AROUND THE BUILDINGS IS TO BE SLOPED MANY FROM THE BUILDING AT ALL THATS AND NO TREES, SHARUBS FIX. SHOULD BE DISCHARGED MIOT THE PIPED SYSTEM. PETERNAL PUMBINES TO BE PROVIDED WITH HEAVANTER FROM DOWNAPIES TO BE PROVIDED WITH HEAVANTER FROM DOWNAPIES TO BE PROVIDED WITH HEAVANTER FROM DOWNAPIES TO BE PROVIDED WITH HEAVANT AND WE WITH HEAVANT THE SUBJECT OF THE STANDARD AND THE STANDARD AND THE SOIL WITH HEAVANT TO THE FOOTINGS, SLOPE TRENCHES SHALL BY NO LOSEIN THAT BUILDING AND BACKFILL WITH CLAY IN THE TOP 300mm WITHIN 2m OF THE BUILDING AND BACKFILL WITH CLAY IN THE TOP 300mm WITHIN 2m OF THE BUILDING AND BACKFILL WITH CLAY IN THE TOP 300mm WITHIN 2m OF

PRECAST PANEL NOTES

1.4L PANELS TO BE REINFORCED WITH SLEZ FABRIC PLACED CENTRALLY

1.4L DANELS TO BE REINFORCED WITH SLEZ FABRIC PLACED CENTRALLY

1.4L PENIFORCEMENT TO BE TIED IN PLACE AND SUPPORTED BY

APPROVED CLIP-ON PLASTIC BAR CHARS PRIOR TO PLACEMENT OF

APPROVED CLIP-ON PLASTIC TIPPED BAR CHARS IS NOT PERMITTED.

CAST-IN LIFTING INSERTS TO BE APPROVED MINIMUM 5 TONNE FACE SHEAR AND FACE TENSION CAPACITY INSTALLED STRICTLY IN ACCORDANCE WITH MANUFACTURERS RECOMMENDATIONS, INSERT LOCATIONS SHOWN THUSA .'. INSERTS TO BE USED ONLY WITH MANUFACTURERS ASSOCIATED LIFTING EQUIPMENT.

3. ONLY SPECIFICALLY APPROVED BOND BREAKING COMPOUND IS TO BE USED IN ACCORDANCE WITH MANUFACTURERS SPECIFICATION. 4. CONCRETE QUALITY TO BE:-

\nn	ž	3	0	NAO.
ASSESSMENT REQUIRED	MIN. MEAN COMPRESSIVE STRENGTH (mm)	MAX. SIZE AGGREGATE (mm)	SLUMP	STRENGTH GRADE (MPa)
PROJECT	MIN. MEAN	MAX SIZE	SLUMP	ヹ

- 5. CONCRETE CURING IS TO BE IN ACCORDANCE WITH CONCRETE NOTES.
- 6. THE WORKSHOP DRAWINGS TO BE SUBMITTED TO THE ENGINEER FOR APPROVAL AT LEAST TO WORKING DAYS PRIOR TO COMMENCEMENT OF CONSTRUCTION, DAWINGS ARE TO INCLUDE CAST-IN STRUCTURAL STEEL CONNECTION PLATE, PANEL LETTING INSERTS AND PROPPING POINT DEFAUS, AND ARE TO BE COORDINATED WITH STRUCTURAL STEEL WORKSHOP DRAWINGS.
- 7, ALL PANEL DIMENSIONS ARE TO BE CHECKED ON SITE AFTER SETTING OUT OF BUILDING AND PRIOR TO BOXING UP FOR POURING ANY DMENSIONS TO BE CHANGED SHALL BE APPROVED BY THE ENGINEER. THE CAST FACE OF PANELS IS TO FORM THE OUTER FACE OF WALLS.
- ERECTION BY APPROVED SHINSPACKERS TO APPEAR BE EGGE DURING
 BEETION BY APPROVED SHINSPACKERS TO APPEAR EXPERIMENT AND
 DOWN OAR POR LATER GROUTING, POSITIONS TO BE GENERALLY ONE
 SIXTH OF THE LEAVEN HOT THE PANEL FROM THE CORNERS OR AS
 APPROVED BY THE ENGINEER, PANELS TO BE BRACED DURING
 CONSTRUCTION BY AN APPROVED ADJUSTABLE STRUTIPSRACHES
 SYSTEM AND SHORED TO THE FLOOR SUIG AND FINET OF THE PANELS
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- 9. SEATING DETAIL INSERTS TO BE APPROVED M20 CAST-IN FERRULES, INSERT LOCATIONS SHOWN THUS '1':
- 10. PANEL ERECTION SEQUENCE TO BE APPROVED BY THE ENGINEER.
- 11. PANEL CASTING SEQUENCE AND CRANE ACCESS ON THE FLOOR SLAB TO BE APPROVED BY THE ENGINEER, THE LIFTING CRANE BEARING PADS ARE TO BE A MINIMUM OF 2.5m² IN AREA AND OF A TYPE APPROVED BY THE ENGINEER.
- TO CASTAIN FERRILLES FOR STRUCTURAL STEEL ROOF FRANKIS ARE TO BE APPROVED ME AND MAD FRENLES AS NOTED ON THE DRAWNIGS AND ON THE PANEL ELEVATIONS, LOCATIONS AS PER THE DETAILS AND CONFIRMED BY REFERENCE TO THE STRUCTURAL STEELMORK SHOP DRAWNIGS, CROSSEARS THRU FERRILLES TO BE WELDED TO PANEL. RENGORCEMENT.
- 18 LECTRICAL, AND MECHANICAL SERVICES CABLING CONDUTTS TO BE
 CAST INTO PAREES IN POSITIONS COORDINATES WITH EACH SUBCONTRACTOR AND IN LOCATIONS AS APPROVED BY THE ENGINEER,
 POSITIONS ON THE PARIEL WORKSHOPS DRAWNINGS, CONDUITS TO BE
 PLACED CENTRAL IN PANEL IN 1 LAYER.

BALONNE SHIRE COUNCIL

APPROVED PLANS / AMENDED PLANS

That accompanies a decision notice under the SPA 2009

File Number 1000

Date of Approval 18.03.2

Assessment Mgr / CEO 📯

REINFORCED CONGRETE NOTES

1. MATERIALS AND CONSTRUCTION SHALL COMPLY WITH THE
1. MATERIALS OF:
1. ASSESS CONCRETE STRUCTURES.

ELEMENT	STRENGTH SLUMP GRADE (MPa)	SLUMP	MAX, SIZE AGGREGATE (mm)	ASSESSMENT REQUIRED
FOOTINGS	N25	80	20	YES
BORED PIERS	N32	80	20	YES
CI AB ON GBOIND	NOS.	80	20	YES

- CHEMICAL ADMIXTURES SHALL NOT BE USED WITHOUT THE PRIOR APPROVAL OF THE ENGINEER.

- 4, ALL REMPORCEMENT SHALL BE AS INDICATED:
 IN DINTES GRADE EXION MED SANCES 457.
 R DINTES GRADE 250 R HOT FOLLED PLAN BARS TO ASTROZ.
 SUPL DENOTES WELDED WIRE MESH GRADE EXOL TO ASROSS
 AGTI.
 REMPORCEMENT IS SHOWN DIAGRAMMATICALLY AND NOT
 NECESSARILY SHOWN IN TRUE PROJECTION.
- S ALL RENFORCEMENT TO BE SUPPORTED IN POSITION DURING FOURING BY USE DE CHAIRS AN NOT GREATER THAN IN METRE CRUTERS BOTH WAYS. ALL STARTER BARS ARE TO BE POSITIONED AND TIES PROFIT TO POURING TO ADMINISTER BARS INTO WET OWNERT IS NOT PERMITTED. JULIESS NOTED OTHERWISE PROFIDE THE POLICY WINDS CLEAR CONCRETE COVER TO REINFORCEMENT.

FOOTINGS, BORED PIERS	50
SLAB ON GROUND	30 TOP
SELECT TO BE MADE ONLY IN POSITIONS	MADE ONLY IN POSITIONS

THE BY THE WINES APPROVED IN WHITING BY THE ENGINEER.

AND THE BY ALD IN ACCORDANCE WITH ASSESS AND INCT. IESS

THAN THE EPACLOPICATE INSTANCTION FOR AND INCT. IESS

THAN THE EPACLOPICATION FOR THE STANCT IN A SECOND IN THE STANCT IN ALTO SEPERAMITED UNLESS SHOWN ON THE STRUCT IN ALL DRAWNS ON A PROVIDED BY THE SHOINEER, PARIC

TO BE LAPED BY TRANSVENSE BASS PLUS SOMM. 2 BARS 2 BARS



12. ALL CONCRETE SURFACES TO BE CURED BY AN APPROVED METHOD IMMEDIATELY AFTER FINISHING AND CONTINUE FOR A MINIMUM OF SEVEN DAYS.

2, CONCRETE QUALITY TO BE:-

ENT	STRENGTH SLUMP GRADE (MPa)	SLUMP	MAX, SIZE AGGREGATE (mm)	PROJECT ASSESSMENT REQUIRED
NGS	N25	80	20	YES
PIERS	N32	80	20	YES
ON GROUND	N25	80	20	YES

SPLICES IN REINFORCEMENT TO BE MADE ONLY IN POSITIONS SHOWN OR OTHERWISE APPROVED IN WRITING BY THE ENGIN	SLAB ON GROUND	FOOTINGS, BORED PIERS	ELEMENT	
BE MADE ONLY IN POSITIONS	30 TOP	50	COVER (mm)	

OTINGS, BORED PIERS	50
AB ON GROUND	30 TOP
LICES IN REINFORCEMENT TO BE MADE ONLY IN POSITIONS	BE MADE ONLY IN POSITIONS
OWN OR OTHERWISE APPROVED IN WRITING BY THE ENGI	ED IN WRITING BY THE ENGIN
PS TO BE MADE IN ACCORDANG	E WITH AS3600 AND NOT LE

#8

THE REIMPORCEMENT STEEL. SUPPLIER MUST BE CERTIFIED BY A CREW (MISTRALMA) STANDARDOS CERTIFICATION & CERTIFICATION OF A CREW (MISTRALMA) STANDARDOS CERTIFICATION & STEELS) FOR THE SUPPLICA FREE STANDARDOS CREW (MISTRALMA) STEEL OF THE MISTRALMA CREW (MISTRALMA) STEEL OF THE MISTRALMA CREW (MISTRALMA) STEEL OF THE CHOINERS AND A CREW (MISTRALMA) STEEL OF THE CREW OF THE DESCRIPTION OF THE MISTRALMA CREW (MISTRALMA) STEEL OF THE MISTRALMA CREW (MISTRALMA CREW

ALL CONCRETE TO BE COMPACTED DURING PLACEMENT BY MECHANICAL VIBRATORS.

9. NO CONCRETE IS TO BE PLACED WHEN SITE TEMPERATURE IS OUTSIDE THE RANGE OF 5°C AND 35°C.

10. CONDRETE PLACED DURING ADVERSE DRYING CONDITIONS SHALL HAVE AN EVAPORATIVE RETARDAYT (SUCHAS WET COVERLIN OR APPROVED EQUIVALENT) APPLIED MINEID/NETLY AFER APPROVED COLVALENT) APPLIED MINEID/NETLY AFER APPLIED AS A CURING METHOD.

11. CONSTRUCTION JOINTS SHALL BE PROPERLY FORMED AND USED ONLY WHERE DETAILED OR SPECIFICALLY APPROVED BY THE ENGINEER.

13. THE ENGINEER IS TO BE GIVEN 24 HOURS NOTICE FOR REINFORCEMENT INSPECTION AND CONCRETE NOT TO BE DELIVERED UNTIL FINAL APPROVAL IS GIVEN.

14. BOTTOM OF ALL TRENCHES AND BORED PIERS TO BE CLEANED OF ALL LOOSE MATERIALS AND WATER.

15, NO CONCRETE IS TO BE DROPPED FROM A HEIGHT GREATER THAN 2000mm, CONCRETE TO BE PLACED USING A TREMIE PIPE OR PUMP EXTENDING TO BASE OF FOOTING OR PIER.

8, THE BUILDER IS TO PROVIDE ALL MISCELLANGOUS HOLES, CLEATS, BRACKETS, FRIMMERS, BATTUS ET OR EQUIPED TO SUPPORT NONBRACKETS, FRIMMERS, BUTTUS ET OR FORDED TO SUPPORT NONBRACKETS, FRIMETS, SETUDIOSS, WALL AND ROOF FINISHES
FRIMETSK, FRIMETSKINDIN, HORS AND WALLEYS ETC) WHETHER
SPECIFICALLY SHOWN ON ITHE DRAWNINGS OR NOT.

STRUCTURAL STEELWORK NOTES

1. MATERIAL AND CONSTRUCTION TO COMPLY WITH THE REQUIREMENTS
OF-AS4100 STEEL STRUCTURES
 AS1554 SAA STRUCTURAL STEEL WELDING CODE.

 ALL STRUCTURAL STEEL SECTIONS TO BE MINIMUM GRADE 300 AND COMPLY WITH:-AS1163, AS1594, AS3678 AND AS3679 U.N.O.

3. OO NOT SCALE DEF THE STRUCTURAL DRAWNIGS. VERIFY ALL SETOUT DIMENSIONS WITH THE BUILDING DE MAY THERE COPIES OF THE WORKSHOP FABRICATION DRAWNINGS TO BE SUBMITTED TO THE ENGINEER FOR APPROYAL AT LEAST 10 WORKING DAYS PRIOR TO COMMENCEMENT OF FABRICATION.

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PT 1951270 COCARDIMITOR ISSUE
PT 1851270 COCARDIMITOR ISSUE
PT 1851270 COCARDIMITOR ISSUE
PT 231270 1007K-50 ISSUE

A, UNE SES OFHERWISE NOTED.

ALL BUTST OR BE MORE BEST IN 22mm6 HOLES

ALL FILLET WELDS TO BE SOM CONTINUOUS FILLET FROM E48XX GP

MILD STEEL BLOTTROPES.

ALL BUTT NELDS TO BE FULL PENETRATION

ALL BUTT WELDS TO BE FULL PENETRATION SHALL HAVE LESS

THA! 2 BUTS U.H.Q.

PURLINGIST SOLET ST TO BE MIT 2 4.6/5 WITH INTEGRAL WASHERS.

5. BOLT TYPES AND BOLTING PROCEDURES ARE DESIGNATED AS FOLLOWS:-

AGE REFERS TO COMMERCIAL BOLTS SMUGTIGHTENED.

AGE REFERS TO HIGH STREAGTH STRUCTURAL BOLTS SMUGTISHED.

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THE THE DU SAPAGED BEYOND THE MUT BOTH THE MUT HAS DEEN.

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THE THE SAPAGE BOTH THE MUT HAS DEEN.

THE SAPAGE BOTH THE

7. TEMPORARY BRACING NECESSARY TO STABILISE THE STRUCTURES DURING ERECTION SHALL BE PROVIDED BY THE CONTRACTOR, BRACING IS TO REMAIN IN POSITION UNIT THE BIGINEER INSPECTS AND APPROVES THE PERMANENT BRACING ELEMENTS OF THE COMPLETED STRUCTURE.

ALL STRUCTURAL STEEL WORK SHALL BE TREATED IN ACCORDANCE
 WITH THE ARCHITECTURAL SPECIFICATION. SHOULD NO SPECIFICATION
 BE PROVIDED THE MINIMUM SUBFACE PROTECTION SHALL BE IN
 ACCORDANCE WITH NOTES BELOW.

BE FREE FROM FAMIL WITH, WELDING IS COMPLETED AND MIL SCALE

ARE CONDITION, USEFACE PREVAIRED AS SECRETIONS TO

PREDIMALENT COLOURIC GERY, AREAS REQUIRENTS SITE WELDING TO

REQUIRACENT COLOURIC GERY, AREAS REQUIRENTS SITE WELDING TO

RECHARGE FROM FAMILY UNTIL WELDING IS COMPLETED AND CLEANED UP.

10. ALL STEELWORK (LOCATED SHALL BE EXTERNALLY SHALL BE HOT DIP GALVANISED, THICKNESS TO BE A MINIMUM OF:
- BOOGHT FOR MEMBERS * SIMIT THICK (EQUIV. THICKNESS 85 Jm) 'P4'
- 450g/m' FOR MEMBERS * Simit THICK

11. PROVIDE SEAL PLATES TO ALL HOLLOW SECTIONS, WITH BREATHER' HOLES IF MEMBER TO BE HOT DIPPED GALVANIZED.

12. OVERSEAS SOURCE STRUCTURAL STEEL IS NOT PERMITTED UNLESS THE STRUCTURAL STEEL MATERIAL SUPPLIER IS CERTIFIED BY ACRS





				COMPATABLE ENGINEERA
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DEPARTMENT OF NATURAL RESOURCES, MINES & ENERGY


ST GEORGE HARMONY CENTRE 72-76 ST GEORGE'S TERRACE, ST GEORGE, QLD 4487

SCHEMATIC DESIGN


IONED 87 PROJECT S1920193	202	DRAWING		APPROVED
PROJECT		NUMBER	20	CHECKED
	\$19201	PROJECT	¥	NWWIG
SIGN AND ORIGINAL SIZE	azt	ORIGINAL	116	DESIGN

DATE

NUMBER

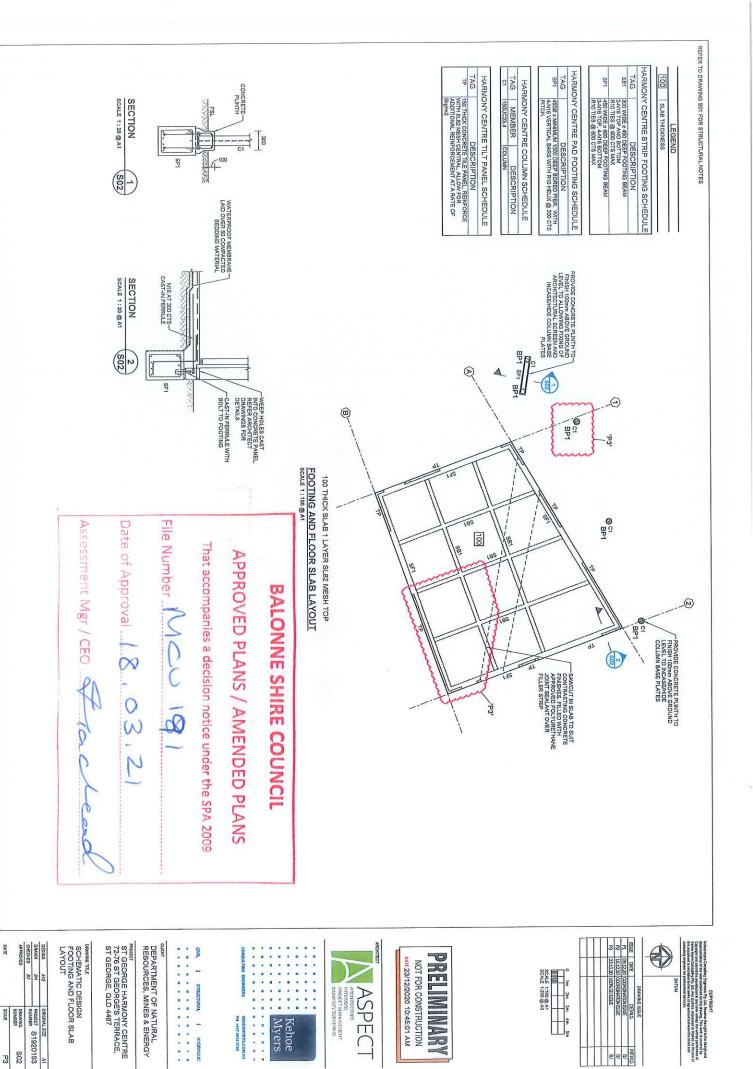

DATE

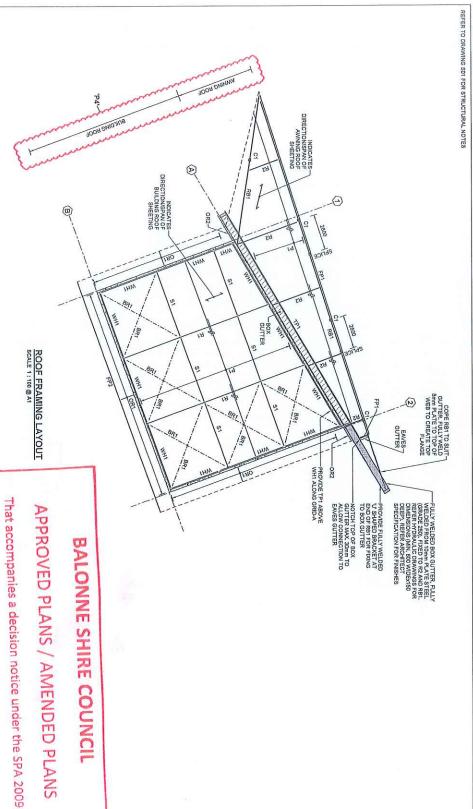

BALONNE SHIRE COUNCIL

APPROVED PLANS / AMENDED PLANS

File Number NCC

Date of Approval 18,03,4

TAG MEMBER
BR1 20mm0
FP1 C150-12
FP2 75x50x3RHS
OR1 1008T15

HARMONY CENTRE FRAMING SCHEDULE

DESCRIPTION

ROOF FRAMING SCHEDULE FOR SHEET ROOF
ROOF SHEETING
ROUTING ROOF)
ROOF SHEETING
ROOF SHEETING
LYSAGHT TRIMDEK 0.48BMT
ROWNING ROOP)

-'P4'

OR2 150PFC P1 Z150-12

APERED OUTRIGGER (75 MIN. DEEP AT EDGE OF ROOF) RLINS AT 1000 CTS. MAX. PPED WITH 1 ROW OF IDGING PER BAY

NOTE

REFER ARCHITECT SPECIFICATION FOR ALL STRUCTURAL STEEL WORK FINISHES


TAG MEMBER C1 150UC23.4

DESCRIPTION

HARMONY CENTRE COLUMN SCHEDULE

VALL HEAD LLI

Assessment Mgr / CEO Lac

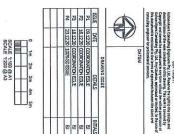





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DEPARTMENT OF NATURAL RESOURCES, MINES & ENERGY

PROJECT
ST GEORGE HARMONY CENTRE
72-76 ST GEORGE'S TERRACE,
ST GEORGE, QLD 4487

SCHEMATIC DESIGN ROOF FRAMING LAYOUT

-		-	-	
DATE	APPROVED	CHECKED	DRAWN	DESIGN
		63	2	MG
Buca	DRAWING	NUMBER	PROJECT	ORIGINAL SIZE
P4	S03	0.000	\$1920193	SIZE A1

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DATE	APPROVED	CHECKED	DRAWN	DEDIGIN
		63	2	MIN
BUDSE	DRAWING	NUMBER	PROJECT	ONIGHT OF
P4	S03	0.000	\$1920193	OLEY. VI